ROBERT LAGA Chairman

TOWN OF CARMEL ENVIRONMENTAL CONSERVATION BOARD

BOARD MEMBERS

Edward Barnett

Anthony Federice

NICHOLAS FANNIN Vice Chairman

RICHARD FRANZETTI, P.E. Wetland Inspector

ROSE TROMBETTA Secretary

60 McAlpin Ave

60 McAlpin Avenue Mahopac, New York 10541 Tel. (845) 628-1500 - Ext. 190 www.ci.carmel.ny.us

ENVIRONMENTAL CONSERVATION BOARD AGENDA

MARCH 4, 2021 - 7:30 P.M.

EXTENSION OF WETLAND PERMIT

<u>APPLICANT</u>	<u>ADDRESS</u>	TAX MAP #	<u>COMMENTS</u>
1. MK Realty	Route 6 & Old Route 6	55.6-1-44&45	Site Plan

ELIGIBLE FOR A PERMIT

2. Brown, Brett	161 West Lake Blvd	64.19-1-85	Construct Deck
3. Schoenbeck, Uwe	252 West Lake Blvd	64.16-1-31	Addition to Existing House in Buffer

SUBMISSION OF AN APPLICATION OR LETTER OF PERMISSION

4. House of Prayer & Worship	361 Hill Street	64.6-1-14	Parking Lot & Drill Well
5. Haberman, Seth	70 Lillian Road	64.15-1-53	50 s.f. of New Foundation & Concrete Footing

MISCELLANEOUS

6. Minutes - 11/19/20 & 01/21/21



March 1, 2021

Town of Carmel Environmental Conservation Board Carmel Town Hall 60 McAlpin Avenue Mahopac, New York 10541

RE: MK Realty Site Plan

U.S. Route 6 and Old Route 6 Tax Map #55.06-1-44 & 45

Town of Carmel Wetland Permit #844

Dear Chairman and Members of the Board:

This letter has been prepared to request an approval extension of Wetland Permit #844. At the time of the last wetland permit extension in March of 2019, your Board had decided to amend the permit to have run concurrently with the Planning Board Site Plan Approval which was set to expire in March of 2021. The applicant received a re-grant of Site Plan Approval at the February 24, 2021 Planning Board meeting and is now seeking extension of the wetland permit. Enclosed herewith please find the updated Approval List for the Board's reference.

The project plans have not changed and no contruction activities have taken place on the property since the wetland permit was issued by your Board in 2011. As you are aware, the applicant is actively searching for a user for the approved commercial development of the site. Should any site plan revisions be required in support of a potential user on the property, it is understood that an amended site plan approval will be required by the Planning Board and a new wetland permit will be required from your Board.

If you have any questions or comments, please feel free to contact our office.

Very truly yours,

INSITE ENGINEERING, SURVEYING & LANDSCAPE ARCHITECTURE, P.C.

JJC/zmp

cc: Kevin Dwyer

Insite File No. 04235.100

Jeffrey J. Contelmo, P.E. Senior Principal Engineer



MK REALTY APPROVAL LIST March 1, 2021

AGENCY	APPROVAL	EXPIRATION DATE
Carmel Planning Board	Site Plan	March 11, 2023
Carmel Environmental	Wetland Permit	March 14, 2021
Conservation Board		
Putnam County Department of	Sewer	February 20, 2023
Health		
New York City Department of	Sewer	January 19, 2026
Environmental Protection		·
New York City Department of	Stormwater Pollution	August 16, 2026
Environmental Protection	Prevention Plan	
New York State Department of	Highway Work Permit	Transferred to the new
Transportation		NYSDOT Permit in May
		of 2015.
		(No Expiration Date)
New York State Department of	Stormwater Pollution	General Permit Coverage
Environmental Conservation	Prevention Plan	obtained March 19, 2011.
	Coverage	(No Expiration Date)

ROBERT LAGA Chairman

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ROSE TROMBETTA Secretary 60 McAlpin Avenue Mahopac, New York 10541 Tel. (845) 628-1500 - Ext. 190 www.ci.carmel.ny.us

APPLICATION FOR WETLAN	ID PERMIT	OR LETTER	OF PERMISSION
-------------------------------	-----------	-----------	---------------

Address of Applicant: 107 Clarkson Rd, Carmel, NY 10512 Email: edgarevans77@gmail.com
Telephone# 914-409-6386 Name and Address of Owner if different from Applicant:
Property Address: 365 Hill Street, Mahopac, NY 10541 Tax Map # 64.06-1-14 Agency Submitting Application if Applicable: N/A Location of Wetland: North of Site
Size of Work Section & Specific Location: Parking Lot for church & Drill Well
Will Project Utilize State Owned Lands? If Yes, Specify: No
Type and extent of work (feet of new channel, yards of material to be removed, draining, dredging, filling, etc). A brief description of the regulated activity (attach supporting details). Parking lot for Church & Drill Well
Proposed Start Date: 4/1/2021 Anticipated Completion Date: 6/1/2021 Fee Paid \$ 225.00
CERTIFICATION

Short Environmental Assessment Form Part 1 - Project Information

Instructions for Completing


Part 1 – Project Information. The applicant or project sponsor is responsible for the completion of Part 1. Responses become part of the application for approval or funding, are subject to public review, and may be subject to further verification. Complete Part 1 based on information currently available. If additional research or investigation would be needed to fully respond to any item, please answer as thoroughly as possible based on current information.

Complete all items in Part 1. You may also provide any additional information which you believe will be needed by or useful to the lead agency; attach additional pages as necessary to supplement any item.


Part 1 – Project and Sponsor Information		
Name of Action or Project:		
House of Prayer		
Project Location (describe, and attach a location map):		
365 Hill Street, Mahopac, NY 10541		
Brief Description of Proposed Action:		
Re-open existing Church & Parking Lot and Drill Well		
Name of Applicant or Sponsor:	Telephone: 914-409-3686	6
House of Prayer		
Address:	E-Mail: edgarevans77@g	jmail.com
107 Clarkson Rd		
City/PO:	State:	Zip Code:
qCarmel	NY	10512
1. Does the proposed action only involve the legislative adoption of a plan, loca administrative rule, or regulation?	l law, ordinance,	NO YES
If Yes, attach a narrative description of the intent of the proposed action and the e	nvironmental resources th	at 🔽 🗀
may be affected in the municipality and proceed to Part 2. If no, continue to ques		at 🗸 📗
2. Does the proposed action require a permit, approval or funding from any other	er government Agency?	NO YES
If Yes, list agency(s) name and permit or approval: Planning Board & Building Dept.		
3. a. Total acreage of the site of the proposed action?	0.2 acres	
b. Total acreage to be physically disturbed?	0.1 acres	
c. Total acreage (project site and any contiguous properties) owned or controlled by the applicant or project sponsor?	0.2 acres	
	o.z acres	
4. Check all land uses that occur on, are adjoining or near the proposed action:		
5. Urban Rural (non-agriculture) Industrial Commercia	al Residential (subur	ban)
Forest Agriculture Aquatic Other(Spec		
Parkland	,,,,,,,,,,,,,,,,,,,,,,,,,,,,,,,,,,,,,,	
I arriand		

5. Is the proposed action,	NO	YES	N/A
a. A permitted use under the zoning regulations?	П	1	П
b. Consistent with the adopted comprehensive plan?		V	
6. Is the proposed action consistent with the predominant character of the existing built or natural landscape?		NO	YES
			V
7. Is the site of the proposed action located in, or does it adjoin, a state listed Critical Environmental Area?		NO	YES
If Yes, identify:		1	
8. a. Will the proposed action result in a substantial increase in traffic above present levels?		NO	YES
b. Are public transportation services available at or near the site of the proposed action?		V	
c. Are any pedestrian accommodations or bicycle routes available on or near the site of the proposed		√	
action? 9. Does the proposed action meet or exceed the state energy code requirements?		NO NO	YES
If the proposed action will exceed requirements, describe design features and technologies:		NO	163
		П	
10. Will the proposed action connect to an existing public/private water supply?		NO	YES
If No, describe method for providing potable water:			
		Ш	\checkmark
11. Will the proposed action connect to existing wastewater utilities?		NO	YES
If No, describe method for providing wastewater treatment: Holding Tank			
		√	Ш
12. a. Does the project site contain, or is it substantially contiguous to, a building, archaeological site, or district which is listed on the National or State Register of Historic Places, or that has been determined by the		NO	YES
Commissioner of the NYS Office of Parks, Recreation and Historic Preservation to be eligible for listing on the State Register of Historic Places?		✓	
Suite Register of Historic Haces:			
b. Is the project site, or any portion of it, located in or adjacent to an area designated as sensitive for archaeological sites on the NY State Historic Preservation Office (SHPO) archaeological site inventory?		Ш	V
13. a. Does any portion of the site of the proposed action, or lands adjoining the proposed action, contain wetlands or other waterbodies regulated by a federal, state or local agency?	_	NO	YES
b. Would the proposed action physically alter, or encroach into, any existing wetland or waterbody?	-	님	
If Yes, identify the wetland or waterbody and extent of alterations in square feet or acres:	- F		Ш
	1	16 y 4 1 1	48 2000

14. Identify the typical habitat types that occur on, or are likely to be found on the project site. Check all that apply:		
☐ Wetland ☐ Urban ☑ Suburban		
15. Does the site of the proposed action contain any species of animal, or associated habitats, listed by the State or Federal government as threatened or endangered?	NO	YES
	V	
16. Is the project site located in the 100-year flood plan?	NO	YES
	V	
17. Will the proposed action create storm water discharge, either from point or non-point sources?	NO	YES
If Yes,	V	
a. Will storm water discharges flow to adjacent properties?		
b. Will storm water discharges be directed to established conveyance systems (runoff and storm drains)? If Yes, briefly describe:		
18 Door the proposed action include construction about this is a little of the little		
18. Does the proposed action include construction or other activities that would result in the impoundment of water or other liquids (e.g., retention pond, waste lagoon, dam)? If Yes, explain the purpose and size of the impoundment:	NO	YES
If Yes, explain the purpose and size of the impoundment:		
19. Has the site of the proposed action or an adjoining property been the location of an active or closed solid waste	NO	YES
management facility? If Yes, describe:		
		_
20. Has the site of the proposed action or an adjoining property been the subject of remediation (ongoing or completed) for hazardous waste?	NO	YES
If Yes, describe:		
	√	
I CERTIFY THAT THE INFORMATION PROVIDED ABOVE IS TRUE AND ACCURATE TO THE BE MY KNOWLEDGE	ST OF	
Applicant/sponsor/name: House of Prayer Date: 3/1/2021		
Signature:		

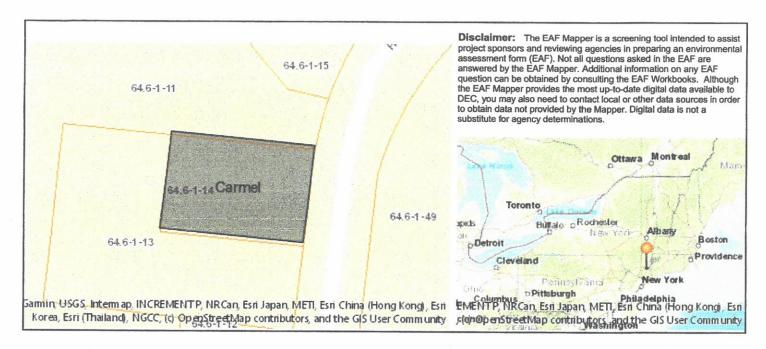

Part 1 / Question 7 [Critical Environmental Area]	No
Part 1 / Question 12a [National or State Register of Historic Places or State Eligible Sites]	No
Part 1 / Question 12b [Archeological Sites]	Yes
Part 1 / Question 13a [Wetlands or Other Regulated Waterbodies]	Yes - Digital mapping information on local and federal wetlands and waterbodies is known to be incomplete. Refer to EAF Workbook.
Part 1 / Question 15 [Threatened or Endangered Animal]	No
Part 1 / Question 16 [100 Year Flood Plain]	No
Part 1 / Question 20 [Remediation Site]	No

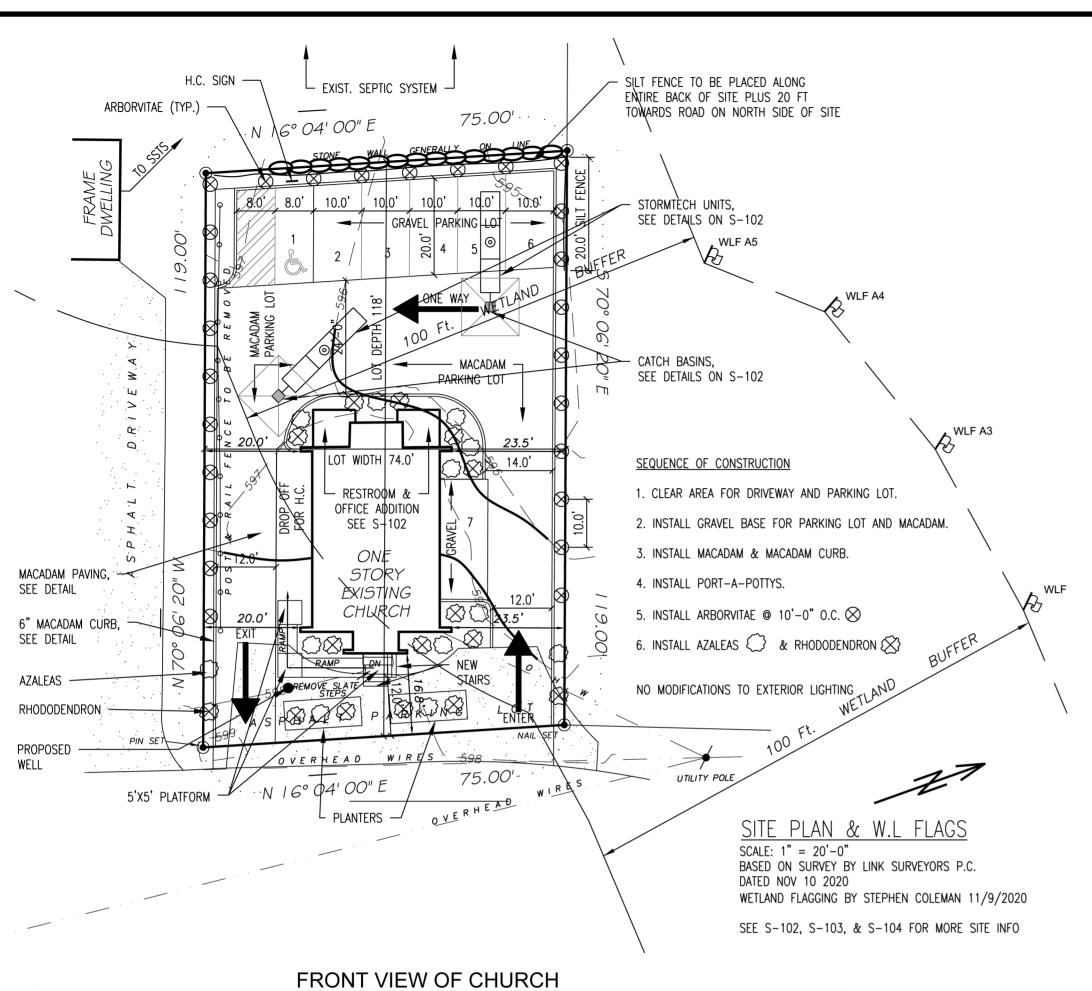

PROPERTIES WITHIN 500 FT

53.18-1-5 64.6-1-48 Bruce L Daul Matthew J Fallon 145 Mexico Ln 16 Stocum Ave Mahopac, NY 10541 Mahopac, NY 10541

> 64.6-1-12 Federico Perruzza 359 Hill St

Frank Servedio 350 Hill St Mahopac, NY 10541

64.6-1-49

64.6-1-13

64.6-1-11 Patrick Higgins 353 Hill St Mahopac, NY 10541

Mahopac, NY 10541

Mark D Hanson 363 Hill St Mahopac, NY 10541

64.6-1-14

Mt Hope United Methodist Churc 3 Grove St New Paltz, NY 12561

Mt Hope United Methodist Churc 70-1101 PO BOX 381

Mahopac Falls, NY 10542

64.6-1-14

53.18-1-12 Joseph Perillo 38 Stonewall Farms Rd Mahopac, NY 10541

64.6-1-15 Bruce L Daul 145 Mexico Ln Mahopac, NY 10541 64.6-1-6 Finbar T Looby Jr 485 Bullet Hole Rd Mahopac, NY 10541

64.6-1-7 Finbar Looby 489 Bullet Hole Rd Mahopac, NY 10541

64.6-1-8 Thomas Brophy 493 Bullet Hole Rd Mahopac, NY 10541 64.6-1-9 John E Dowling 495 Bullet Hole Rd Mahopac Falls, NY 10542

64.6-1-10 William J Bishop 501 Bullet Hole Rd Mahopac, NY 10541

Town of Carmel Zoning Requirements

Basic Data:

Owner: House of Prayer and Worship (Pastor Edgar Evans)


Address: 365 Hill Street, Mahopac, NY 10541

T.M. #: 64.6-1-14

Zoning District: R-120 Proposed Use: Existing Methodist Church, Proposed House of Prayer and Worship Church Poguired/Allowable:

Bulk Regulations:	Required/Allowable:	Existing/Proposed:	Variance Required:
Lot Area:	120,000 SF	8,905 SF	111,095 SF
Lot Width:	200 LF	74 LF	126 FT
Lot Depth:	200 LF	118 LF	82 FT
Parking:	1 Per 3 Seats	51 Seats /3 = 17 (7 PS Provided)	10 Parking Spaces
Front Yard:	25 FT	11.0 FT	14 FT
Side Yard: North	10 FT	23.5 FT	NONE
Side Yard:	10 FT	20 FT	NONE
Rear Yard:	15 FT	48 FT	NONE
Area of Disturbance:	N/A	0 FT Exist. / 4,367 SF	NONE
Parking surface	Macadam	Macadam & Gravel	YES



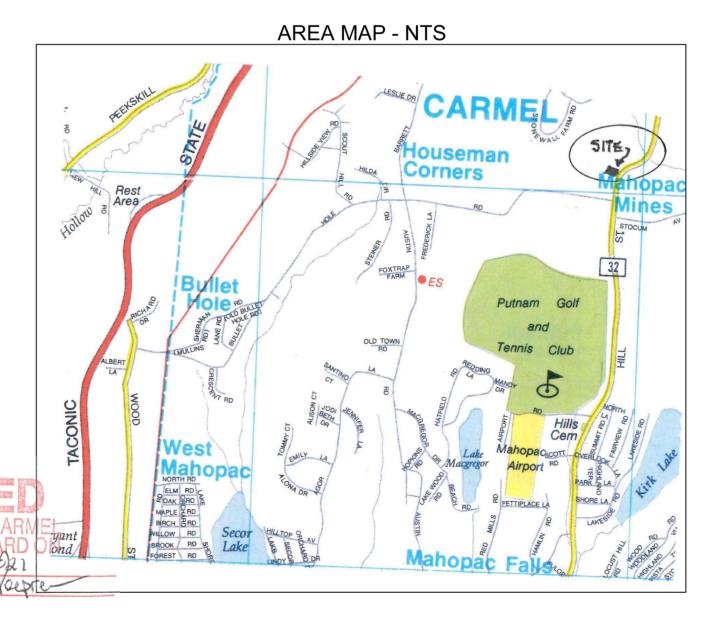

architecturai ISIONS PLLC

2 MUSCOOT ROAD NORTH MAHOPAC NY, 10541 JOEL.GREENBERG@ARCH-VISIONS.COM P: 845-628-6613 F: 845-628-2807

PROJECT:

HOUSE OF PRAYER & WORSHIP PASTOR EDGAR EVANS

PROJECT ADDRESS 365 HILL STREET MAHOPAC, NY 10541 TAX MAP NO. 64.06-1-14 MAILING ADDRESS 107 CLARKSON ROAD CARMEL, NY 10512

SITE PLAN

PROJECT NO. 07-20-070

ISSUANCE DATE FOR REVIEW 11/2/2020 FOR REVIEW 12/3/2020 FOR REVIEW 12/7/2020 FOR REVIEW 12/14/2020 FOR REVIEW 12/14/2020 FOR REVIEW 12/31/2020 FOR REVIEW 11/18/2021 SCALE AS NOTED DRAWN BY/CHKD BY MCK/- /JLG			
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IT IS A VIOLATION OF STATE LAW FOR ANY PERSON, UNLESS ACTING UNDER THE DIRECTION OF A LICENSED ARCHITECT, TO ALTER AN ITEM DOCUMENTS IN ANY WAY. PER STATE LAW, IF AN ITEM BEARING THE SEAL OF AN ARCHITECT IS ALTERED, THE ALTERING ARCHITECT, TO ALTER AN ITEM BEARING THE SEAL OF AN ARCHITECT IS ALTERED, THE ALTERING ARCHITECT, TO ALTER AN ITEM BEARING THE SEAL OF AN ARCHITECT IS ALTERED, THE ALTERING ARCHITECT IS ALTER AN ITEM BEARING THE SEAL OF AN ARCHITECT IS ALTERED, THE ALTERING ARCHITECT IS ALTER AN ITEM BEARING THE SEAL OF AN ARCHITECT IS ALTER AN ITEM BEARING THE SEAL OF AN ARCHITECT IS ALTER AN ITEM BEARING THE SEAL OF AN ARCHITECT IS ALTER AN ITEM BEARING THE SEAL OF AN ARCHITECT IS ALTER AN ITEM BEARING THE SEAL OF AN ARCHITECT IS ALTER AN ITEM BEARING THE SEAL OF AN ARCHITECT IS ALTER AN ITEM BEARING THE SEAL OF AN ARCHITECT IS ALTER AN ITEM BEARING THE SEAL OF AN ARCHITECT IS ALTER AN ITEM BEARING THE SEAL OF AN ARCHITECT IS ALTER AN ITEM BEARING THE SEAL OF AN ARCHITECT IS ALTER AN ITEM BEARING THE SEAL OF AN ARCHITECT IS ALTER AN ITEM BEARING THE SEAL OF AN ARCHITECT IS ALTER AN ITEM BEARING THE SEAL OF AN ARCHITECT IS ALTER AN ITEM BEARING THE SEAL OF AN ARCHITECT IS ALTER AND ARCHITECT IS ALTER ALTERATION. THIS ARCHITECT DENIES ANY AND ALL RESPONSIBILITY FOR ALTERATIONS OF THESE PLANS AND DOCUMENTS BY OTHERS AND EXPRESSLY DENIES PERMISSION TO OTHERS TO ALTER THESE PLANS AND DOCUMENTS.

FRONT LEFT VIEW OF CHURCH (SOUTH)



LEFT VIEW OF CHURCH (SOUTH)



RIGHT VIEW OF CHURCH (NORTH)



REAR VIEW OF CHURCH (WEST)



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TAX MAP NO. 64.06-1-14

PROJECT: HOUSE OF PRAYER & WORSHIP

PASTOR EDGAR EVANS PROJECT ADDRESS 365 HILL STREET MAHOPAC, NY 10541

MAILING ADDRESS 107 CLARKSON ROAD CARMEL, NY 10512

SITE PHOTOS

FOR REVIEW


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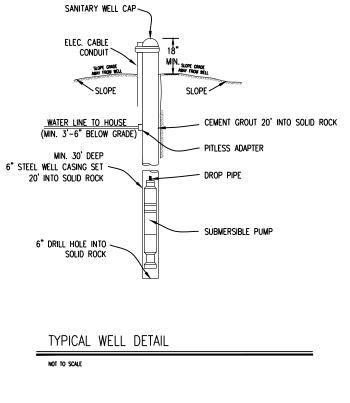
DRAWN BY/CHKD BY MCK/- /JLG PROJECT NO. 07-20-070


S-101

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ALTERATION. THIS ARCHITECT DENIES ANY AND ALL RESPONSIBILITY FOR ALTERATIONS OF THESE PLANS AND DOCUMENTS.





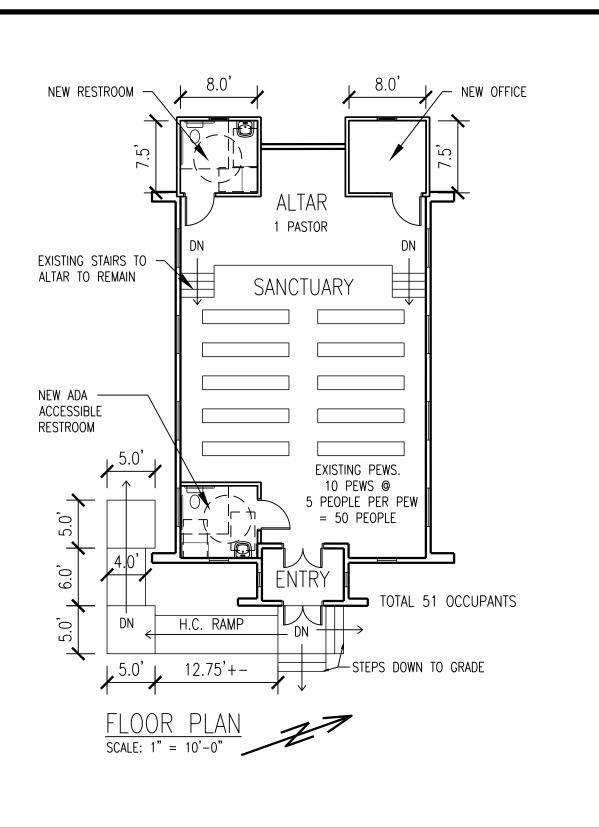

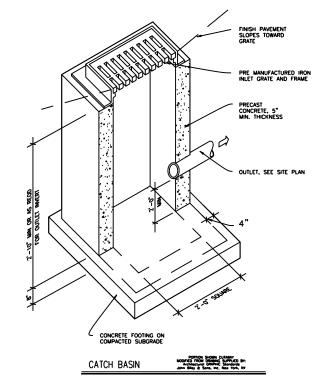STORMTECH UNITS NOTES-

1 H-20 LOADING

2 DEPTH TO GROUND WATER 5 FEET Table 1- Acceptable Fill Materials


Material Location	Description	AASHTO M43 Designation ¹	Compaction/Density Requirement
D Final Fill: Fill Material for layer 'D' starts from the top of the 'C' layer to the bottom of flexible pavement or unpaved finished grade above. Note that the pavement subbase may be part of the 'D' layer.	Any soil/rock materials, native soils or per engineer's plans. Check plans for pavement subgrade requirements.	N/A	Prepare per site design engineer's plans. Paved installations may have stringent material and preparation requirements.
Olnitial Fill: Fill Material for layer 'C' arts from the top of the embedment one ('B' layer) to 18" (450 mm) above e top of the chamber. Note that paveent subbase may be part of the 'C' layer. Granular well-graded soil/ aggregate mixtures, <35% fines or processed aggregate. Most pavement subbase materials can be used in lieu of this layer.		AASHTO M45 A-1, A-2-4, A-3 or AASHTO M431 3, 357, 4, 467, 5, 56, 57, 6, 67, 68, 7, 78, 8, 89, 9, 10	Begin compaction after min. 12" (300 mm) of material over the chambers is reached. Compact additional layers in 6" (150 mm) max. lifts to a min. 95% Proctor density for well-graded material and 95% relative density for processed aggregate materials. Roller gross vehicle weight not to exceed 12,000 lbs (53 kN). Dynamic force not to exceed 20,000 lbs (89 kN)
Embedment Stone: Embedment Clean, crushed, angular stone surrounding chambers from the bundation stone to the 'C' layer above.		AASHTO M43 ¹ 3, 357, 4, 467, 5, 56, 57	No compaction required.
(A) Foundation Stone: Foundation Stone below the chambers from the subgrade up to the foot (bottom) of the chamber.	Clean, crushed, angular stone,	AASHTO M43 ¹ 3, 357, 4, 467, 5, 56, 57	Place and compact in 6" (150 mm) lifts using two full coverages with a vibratory compactor. ^{2,3}


Figure 1- Inspection Port Detail CONCRETE COLLAR CONNECTION DETAIL PORTS MAY BE CONNECTED THROUGH ANY CHAMBER L SCHEDULE 40 FITTINGS TO BE SOLVENT CEMENTED (4" PVC NOT

PLEASE NOTE:

- 1. The listed AASHTO designations are for gradations only. The stone must also be clean, crushed, angular. For example, a specification for #4 stone would state: "clean, crushed, angular no. 4 (AASHTO M43) stone".
- 2. StormTech compaction requirements are met for 'A' location materials when placed and compacted in 6" (150 mm) (max) lifts using two full coverages with a vibratory compactor.
- 3. Where infiltration surfaces may be comprised by compaction, for standard installations and standard design load conditions, a flat surface may be achieved by raking or dragging without compaction equipment. For special load designs, contact StormTech for compaction requirements.

Figure 2 - Fill Material Locations

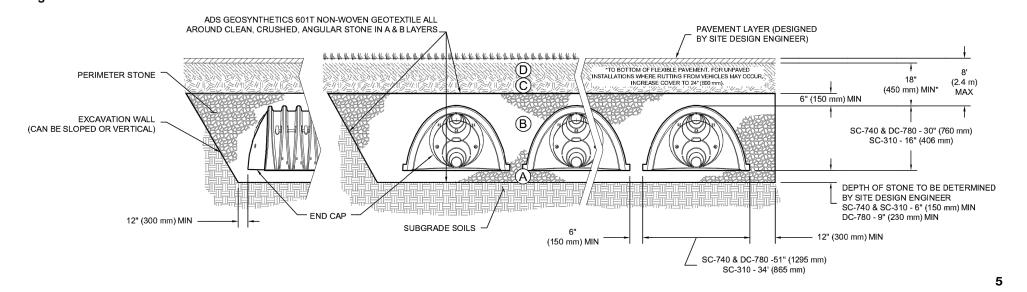

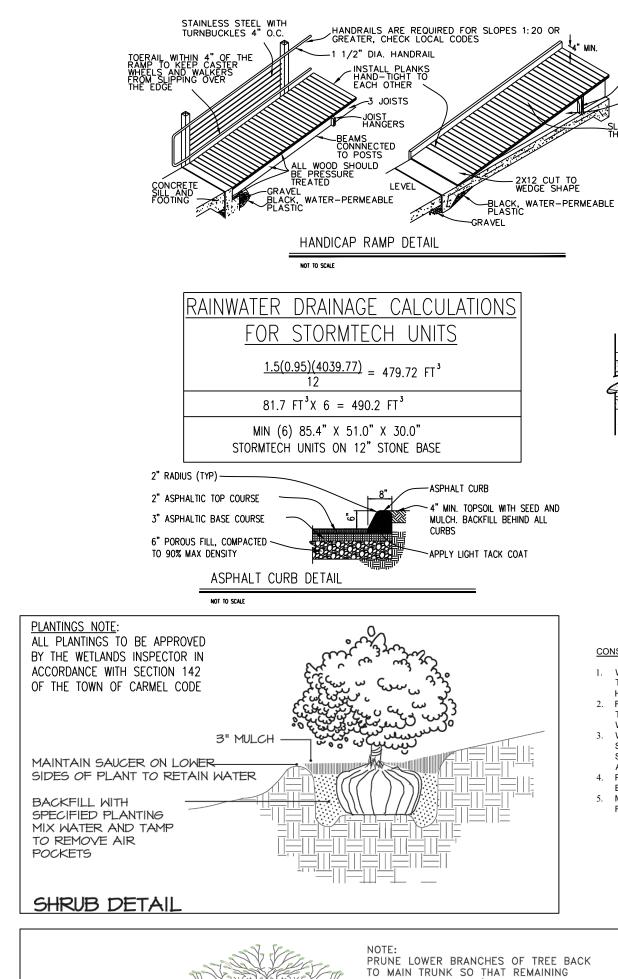



-BALUSTER

12" (305 mm) MIN. HORIZONTAL EXTENSION RAILING

 \dot{X} = RAMP LENGTH (HORIZONTAL PROJECTION OR RUN)

BEAMS CONNECTED TO POSTS

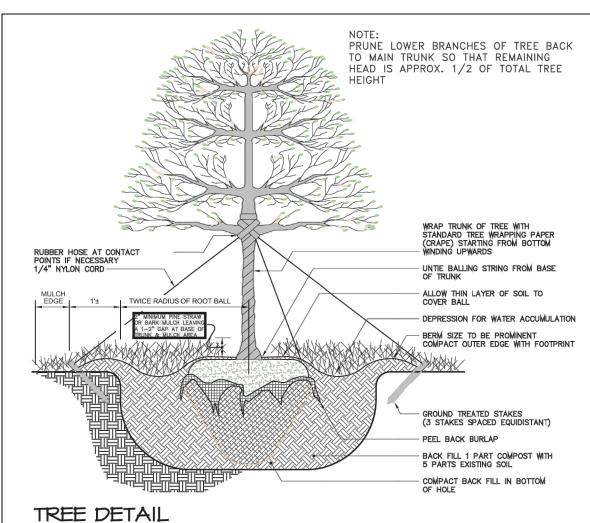

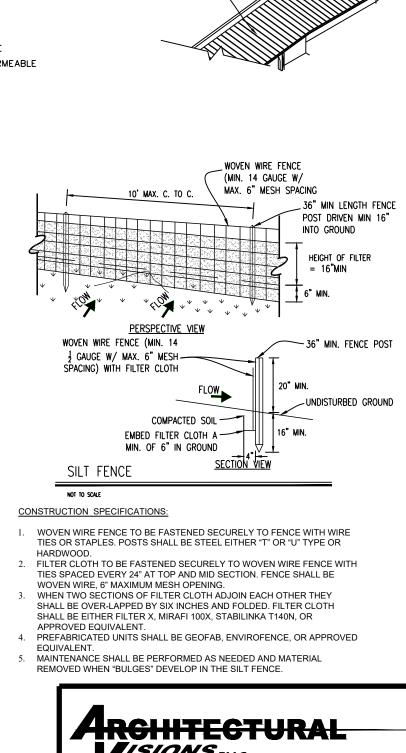

HANDRAILS ARE REQUIRED FOR SLOPES 1:20 OR GREATER, CHECK LOCAL CODES

1 1/2" DIA. HANDRAIL

ISIONS PLLC

2 MUSCOOT ROAD NORTH MAHOPAC NY, 10541 JOEL.GREENBERG@ARCH-VISIONS.COM P: 845-628-6613 F: 845-628-2807

PROJECT:

HOUSE OF PRAYER & WORSHIP MAILING ADDRESS 107 CLARKSON ROAD PROJECT ADDRESS


365 HILL STREET MAHOPAC, NY 10541 CARMEL, NY 10512 TAX MAP NO. 64.06-1-14


DETAILS

PROJECT NO. 07-20-070

ISSUANCE	DATE
FOR REVIEW	11/2/2020
FOR REVIEW	11/16/2020
FOR REVIEW	12/3/2020
FOR REVIEW	12/7/2020
FOR REVIEW	12/14/2020
FOR REVIEW	12/31/2020
FOR REVIEW	1/18/2021
i	
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i	
SCALE	
AS NOTED	ı
DRAWN BY/ MCK/-	JLG
PROJECT	NO

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2 MUSCOOT ROAD NORTH MAHOPAC NY, 10541 JOEL.GREENBERG@ARCH-VISIONS.COM

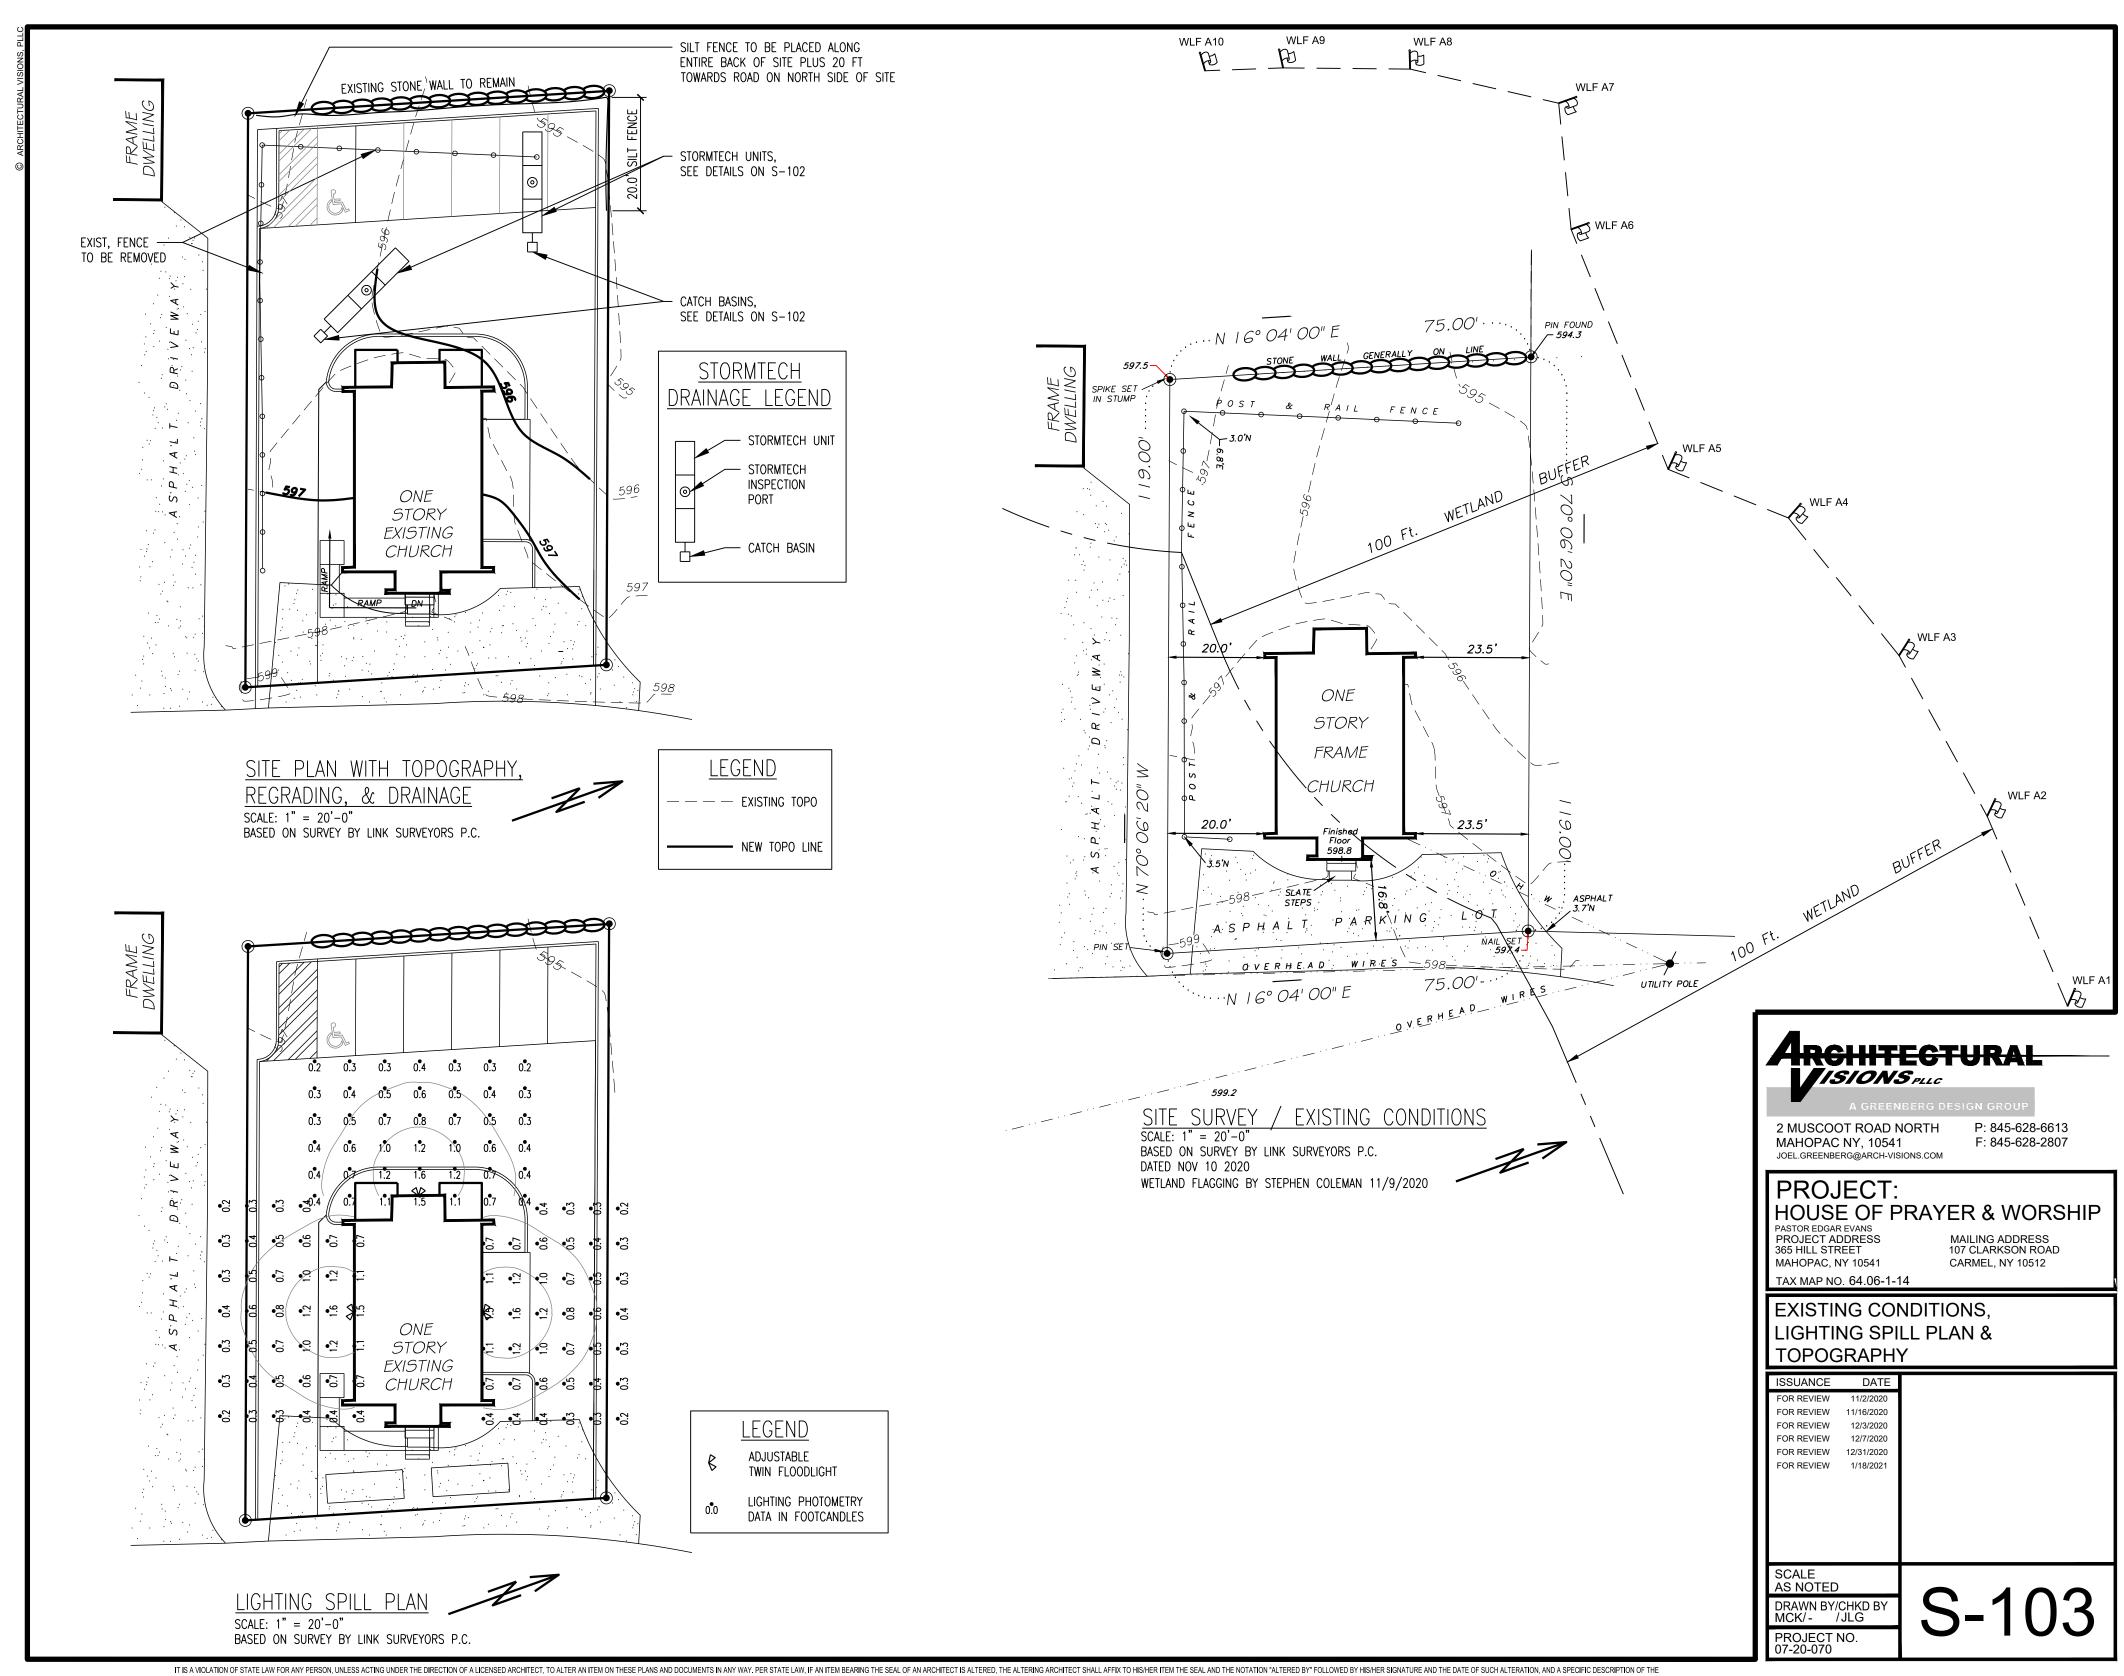P: 845-628-6613 F: 845-628-2807

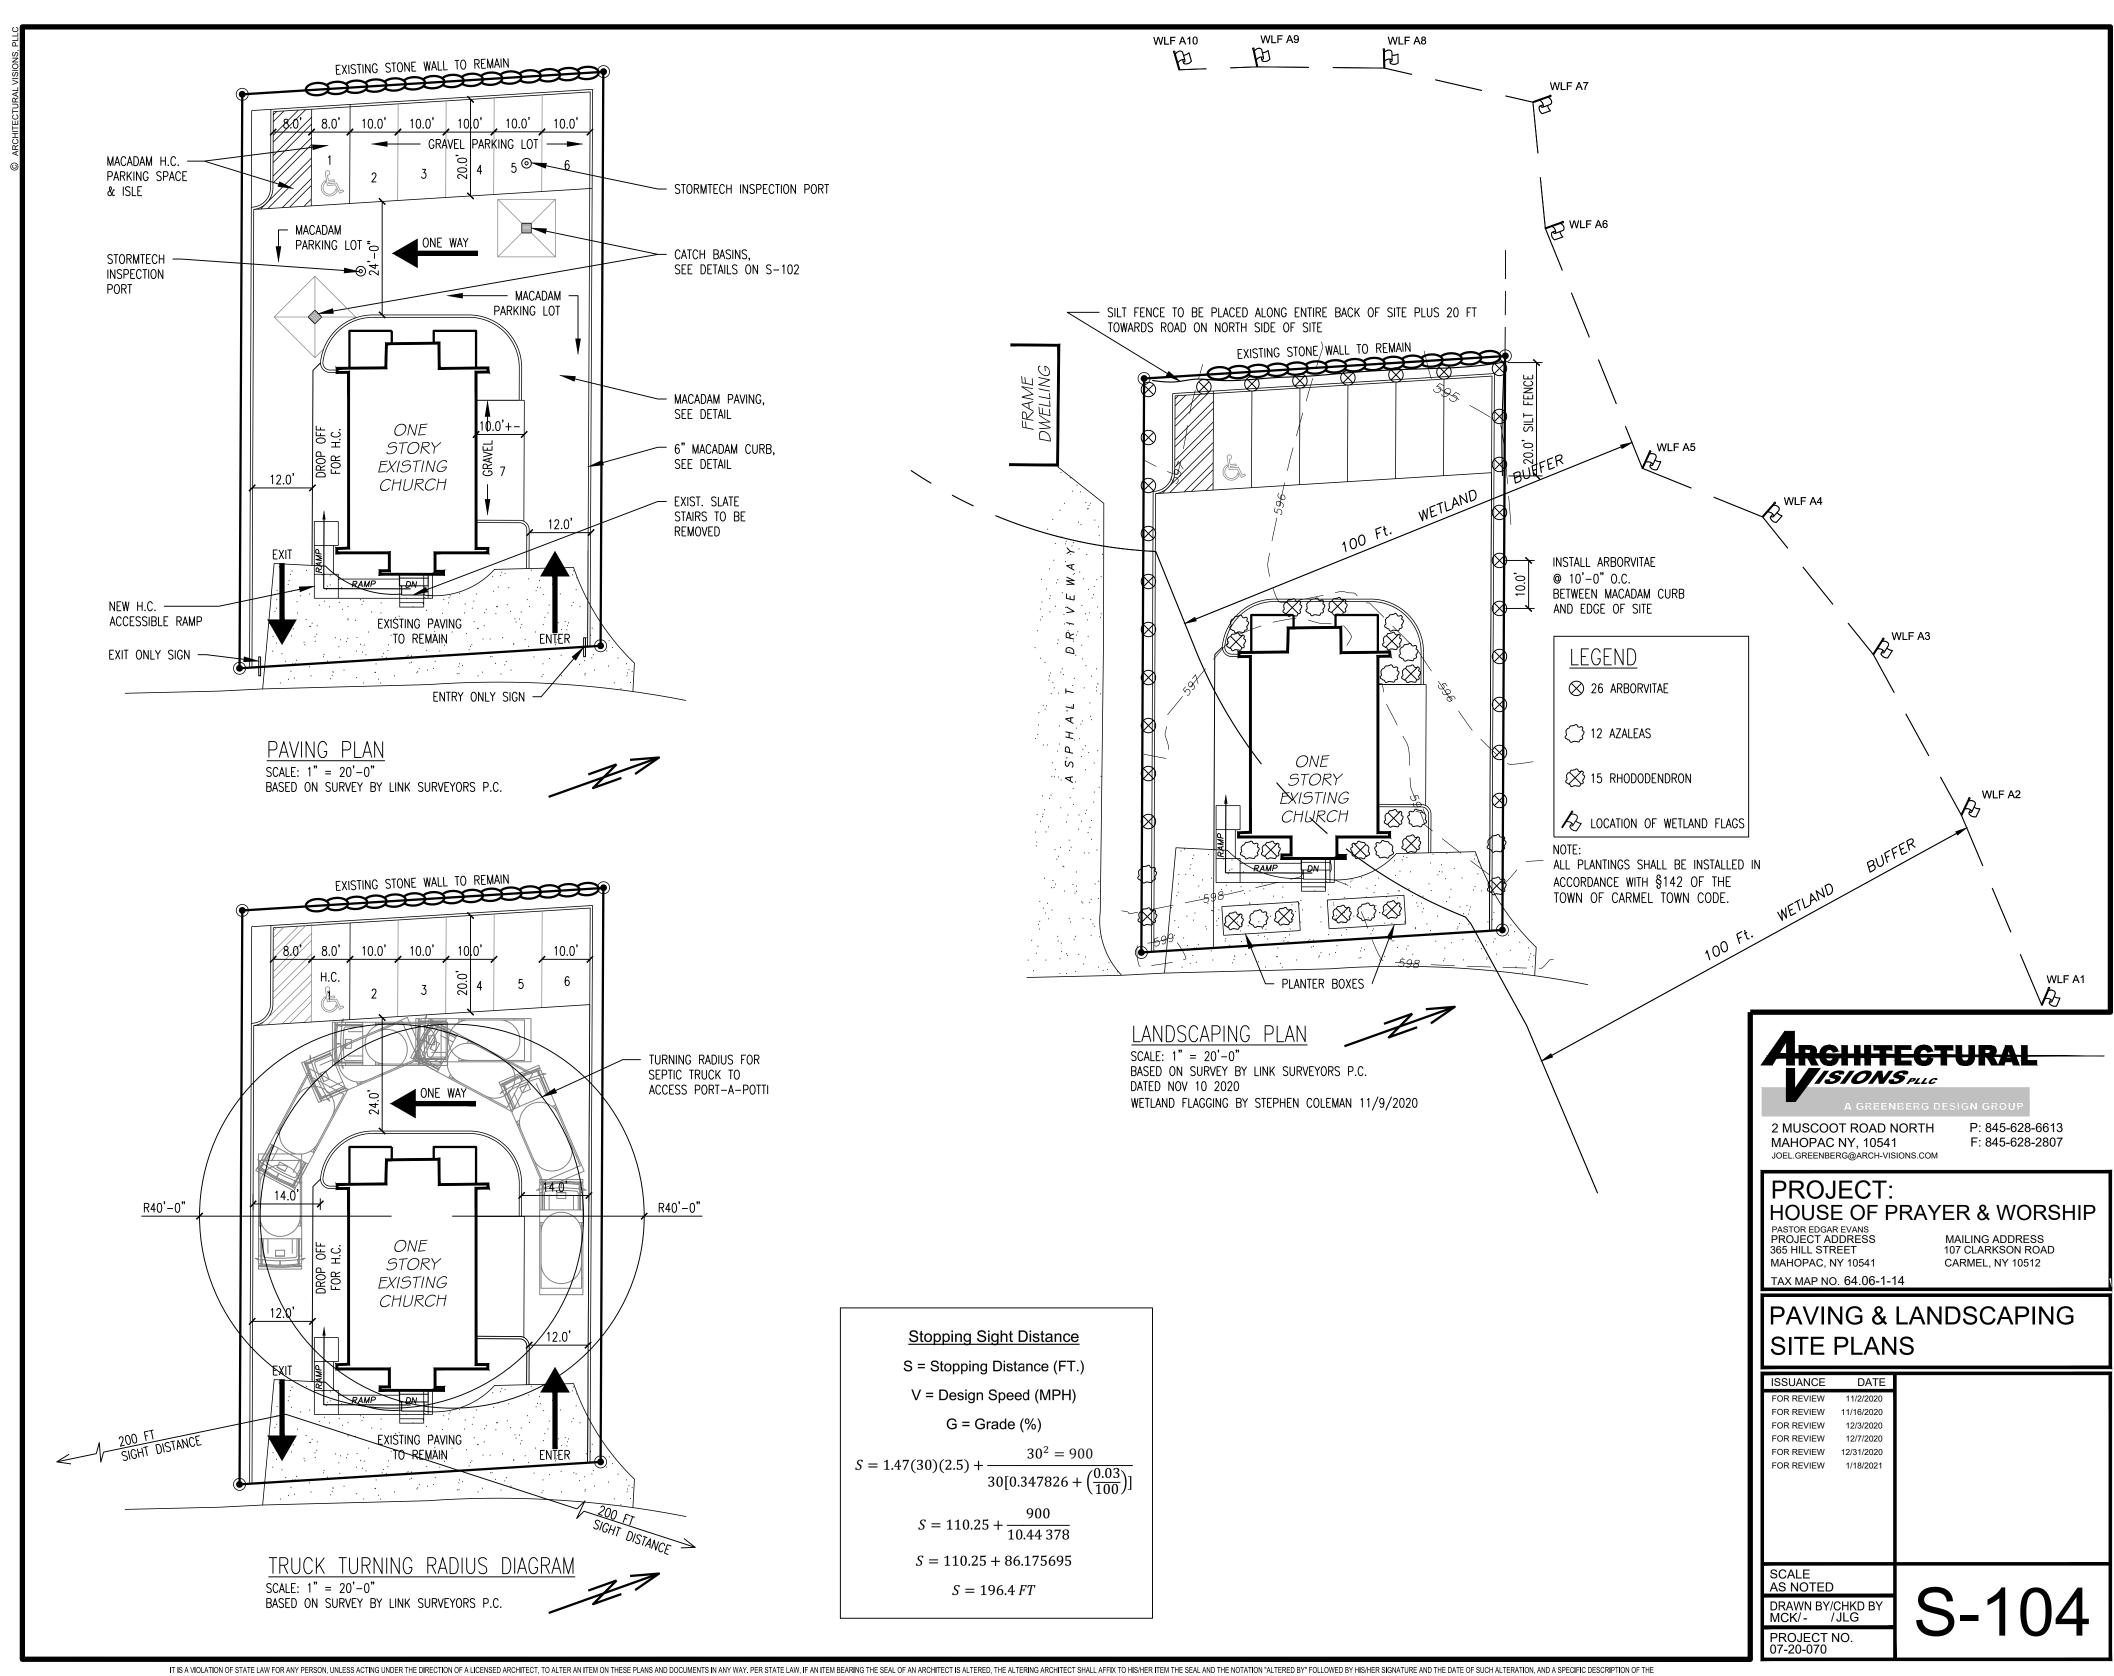PROJECT:
HOUSE OF PRAYER & WORSHIP
PASTOR EDGAR EVANS
PROJECT ADDRESS
365 HILL STREET
MAILING ADDRESS
365 HILL STREET

MAHOPAC, NY 10541

MAILING ADDRESS 107 CLARKSON ROAD CARMEL, NY 10512

RENDERINGS

TAX MAP NO. 64.06-1-14

ISSUANCE	DA
FOR REVIEW	12/31/20
FOR REVIEW	1/18/20

SCALE AS NOTED

DRAWN BY/CHKD BY MCK/- /JLG

PROJECT NO. 07-20-070

ROBERT LAGA Chairman

TOWN OF CARMEL ENVIRONMENTAL CONSERVATION BOARD

BOARD MEMBERS

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60 McAlpin Avenue Mahopac, New York 10541 Tel. (845) 628-1500 - Ext. 190 www.ci.carmel.ny.us

APPLICATION FOR WETLAND PERMIT OR LETTER OF PERMISSION

Name of Applicant: Seth Haberman, owner / Amanda Schachter, Architect			
Address of Applicant: 1 West 85 Street NYC 10025 Email: studio@sloarchitecture.com			
Telephone# 646 824 5786			
Name and Address of Owner if different from Applicant:			
Property Address: 70 Lillian Road, Mahopac NY 10541			
Tax Map # 64.15.1.53			
Agency Submitting Application if Applicable:			
Location of Wetland: Kirk Lake			
Size of Work Section & Specific Location: <u>50 sq ft in area of current deck, and within 100ft of lake</u> Will Project Utilize State Owned Lands? If Yes, Specify: No			
Type and extent of work (feet of new channel, yards of material to be removed, draining, dredging, filling, etc). A brief description of the regulated activity (attach supporting details). 50 sq ft of new foundation and concrete footing in loction of existing deck.			
Proposed Start Date: April 1 2021 Anticipated Completion Date: December 31, 2021			
Fee Paid \$			

CERTIFICATION			
CERTIFICATION I hereby affirm under penalty of perjury that information provided on this form is true to the best of my knowledge and belief, false statements made herein are punishable as a Class A misdemeanor pursuant to Section 210.45 of the Penal Law. As a condition to the issuance of a permit, the applicant accepts full legal responsibility for all damage, direct or indirect, or whatever nature, and by whomever suffered, arising out of the project described here-in and agrees to indemnify and save harmless the Town of Carmel from suits, actions,			

Short Environmental Assessment Form Part 1 - Project Information

Instructions for Completing

Part 1 – Project Information. The applicant or project sponsor is responsible for the completion of Part 1. Responses become part of the application for approval or funding, are subject to public review, and may be subject to further verification. Complete Part 1 based on information currently available. If additional research or investigation would be needed to fully respond to any item, please answer as thoroughly as possible based on current information.

Complete all items in Part 1. You may also provide any additional information which you believe will be needed by or useful to the lead agency; attach additional pages as necessary to supplement any item.


Part 1 – Project and Sponsor Information				
Seth Haberman, owner 70 Lillian Road, Mahopac NY 10541 Name of Action or Project:				
Remodeling of existing House at 70 Lillian Road Mahopac NY 10541				
Project Location (describe, and attach a location map):				
A .37 acre site, located within 100ft of Kirk Lakeremodeling house that currently exists on the	e site.			
Brief Description of Proposed Action:				
We are using the existing foundation and basement of house at 70 Lillian Road, to build a larger house upwards. The perimeter of the new house follows the existing house exactly, plus filling in a 5ft x 9.5ft corner currently occupied by part of the deck, approved in 2008. (and within the zoning requirement limits). The work will also include adding three additional 5"x5" columns with footings (withing the zoning requirements), right along the existing house on the lake side for an overhang, where there is an approved deck with outdoor shower and bathroom currently. We are not disturbing any new/ untouched area on the site.				
Name of Applicant or Sponsor:	Telephone: 646 824 5786	3		
Seth Haberman, owner / Amanda Schachter, architect, contact E-Mail: studio@sloarchitecture.com				
Address:				
1 West 85 Street				
City/PO: State: Zip Code:				
New York	NY	10025		
1. Does the proposed action only involve the legislative adoption of a plan, loca administrative rule, or regulation?	l law, ordinance,	NO YES		
may be affected in the municipality and proceed to Part 2. If no, continue to question 2.				
2. Does the proposed action require a permit, approval or funding from any other government Agency?				
If Yes, list agency(s) name and permit or approval:				
3. a. Total acreage of the site of the proposed action?				
b. Total acreage to be physically disturbed?01 acres				
c. Total acreage (project site and any contiguous properties) owned or controlled by the applicant or project sponsor?				
4. Check all land uses that occur on, are adjoining or near the proposed action:				
5. ☐ Urban ☐ Rural (non-agriculture) ☐ Industrial ☐ Commercial ☑ Residential (suburban)				
Forest Agriculture Aquatic Other(Specify):				
☐ Parkland				

Page 1 of 3

5. Is the proposed action,	NO	YES	N/A
a. A permitted use under the zoning regulations?		V	
b. Consistent with the adopted comprehensive plan?		V	
		NO	YES
6. Is the proposed action consistent with the predominant character of the existing built or natural landscape	?		✓
7. Is the site of the proposed action located in, or does it adjoin, a state listed Critical Environmental Area?		NO	YES
If Yes, identify:			
		V	Ш
8. a. Will the proposed action result in a substantial increase in traffic above present levels?		NO	YES
		\checkmark	
b. Are public transportation services available at or near the site of the proposed action?		V	
c. Are any pedestrian accommodations or bicycle routes available on or near the site of the proposed action?		✓	
9. Does the proposed action meet or exceed the state energy code requirements?		NO	YES
If the proposed action will exceed requirements, describe design features and technologies:			
We are adding a solar integrated roof to the house (replacing the old asphalt shingle) and expect to be able to add energy to t	he grid		✓
10. Will the proposed action connect to an existing public/private water supply?		NO	YES
If No, describe method for providing potable water:			✓
11. Will the proposed action connect to existing wastewater utilities?		NO	YES
If No, describe method for providing wastewater treatment:			
			V
12. a. Does the project site contain, or is it substantially contiguous to, a building, archaeological site, or distri	ct	NO	YES
which is listed on the National or State Register of Historic Places, or that has been determined by the		V	П
Commissioner of the NYS Office of Parks, Recreation and Historic Preservation to be eligible for listing on th State Register of Historic Places?	е		
		X	
b. Is the project site, or any portion of it, located in or adjacent to an area designated as sensitive for archaeological sites on the NY State Historic Preservation Office (SHPO) archaeological site inventory?			
13. a. Does any portion of the site of the proposed action, or lands adjoining the proposed action, contain wetlands or other waterbodies regulated by a federal, state or local agency?		NO	YES 🗸
b. Would the proposed action physically alter, or encroach into, any existing wetland or waterbody?		✓	
If Yes, identify the wetland or waterbody and extent of alterations in square feet or acres:	3		
The entire .37 acre site is within 100ft of Kirk Lake. However, we are not disturbing any part of the site that does not already h construction-either the existing house itself, or deck. (we are using the existing house foundation and basement as the perim the porject.)	ave a eter_of_		

14. Identify the typical habitat types that occur on, or are likely to be found on the project site. Check all that apply:			
Shoreline Forest Agricultural/grasslands Early mid-successional			
✓ Wetland Urban Suburban			
15. Does the site of the proposed action contain any species of animal, or associated habitats, listed by the State or	NO	YES	
Federal government as threatened or endangered?	\checkmark		
16. Is the project site located in the 100-year flood plan?	NO	YES	
	\checkmark		
17. Will the proposed action create storm water discharge, either from point or non-point sources?	NO	YES	
If Yes,			
a. Will storm water discharges flow to adjacent properties?	√		
b. Will storm water discharges be directed to established conveyance systems (runoff and storm drains)? If Yes, briefly describe:	✓		
18. Does the proposed action include construction or other activities that would result in the impoundment of water	NO	YES	
or other liquids (e.g., retention pond, waste lagoon, dam)?	NO	IES	
If Yes, explain the purpose and size of the impoundment:	V		
	•		
19. Has the site of the proposed action or an adjoining property been the location of an active or closed solid waste	NO	YES	
management facility? If Yes, describe:	X		
II Tes, describe.			
	_		
20. Has the site of the proposed action or an adjoining property been the subject of remediation (ongoing or	NO	YES	
completed) for hazardous waste? If Yes, describe:	_		
	\checkmark		
I CERTIFY THAT THE INFORMATION PROVIDED ABOVE IS TRUE AND ACCURATE TO THE BEST OF MY KNOWLEDGE			
Applicant/sponsor/name: Seth Haberman Date: Feb 22 2021			
Signature: Signature: Title: Owner, 70 Lillian Road	5500		

ADDITIONAL CONCRETE FOUNDATION TO BE ADDED TO EXISTING PERIMETER TO COMPLETE CORNER

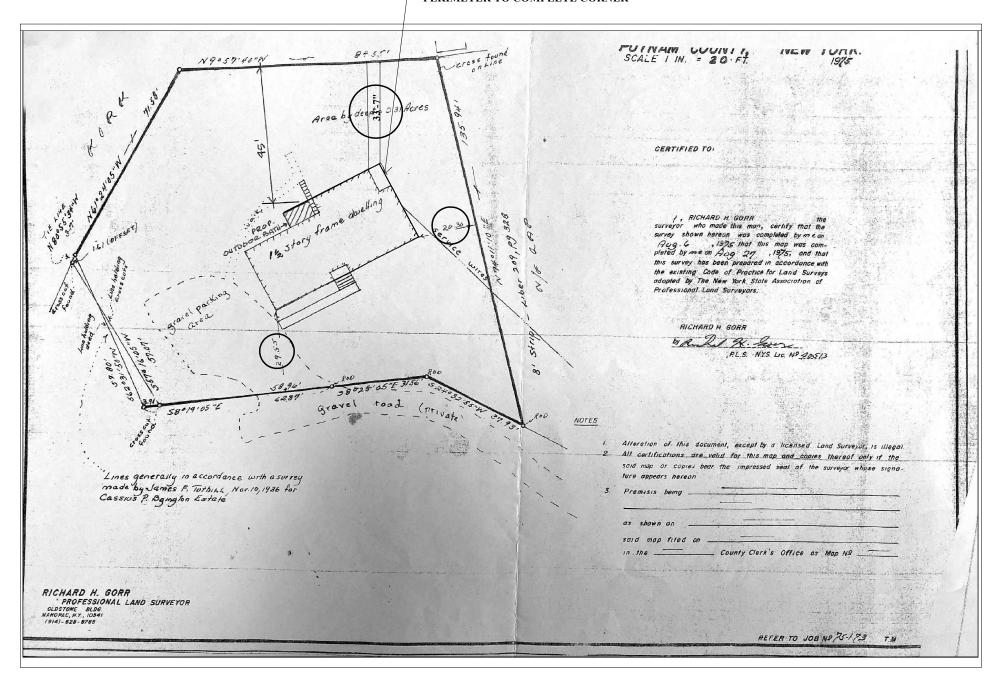

1

SITE SURVEY SHOWING EXISTING HOUSE

SCALE 1/32" = 1' - 0"

KIRK LAKE HOUSE


70 LILLIAN ROAD, MAHOPAC NY 10541

SLO ARCHITECTURE

10-10 44TH AVE, STUDIO 320, LONG ISLAND CITY, NY 11101 646. 824 .5786 www.sloarchitecture.com info@sloarchitecture.com

SITE SURVEY

DATE	FEBRU	ARY 1, 2021
PROJEC [*]	T NO.	2020-04
DRWNG	BY	AS/ DL
CHCK BY		AS
DRAWING	G NO.	

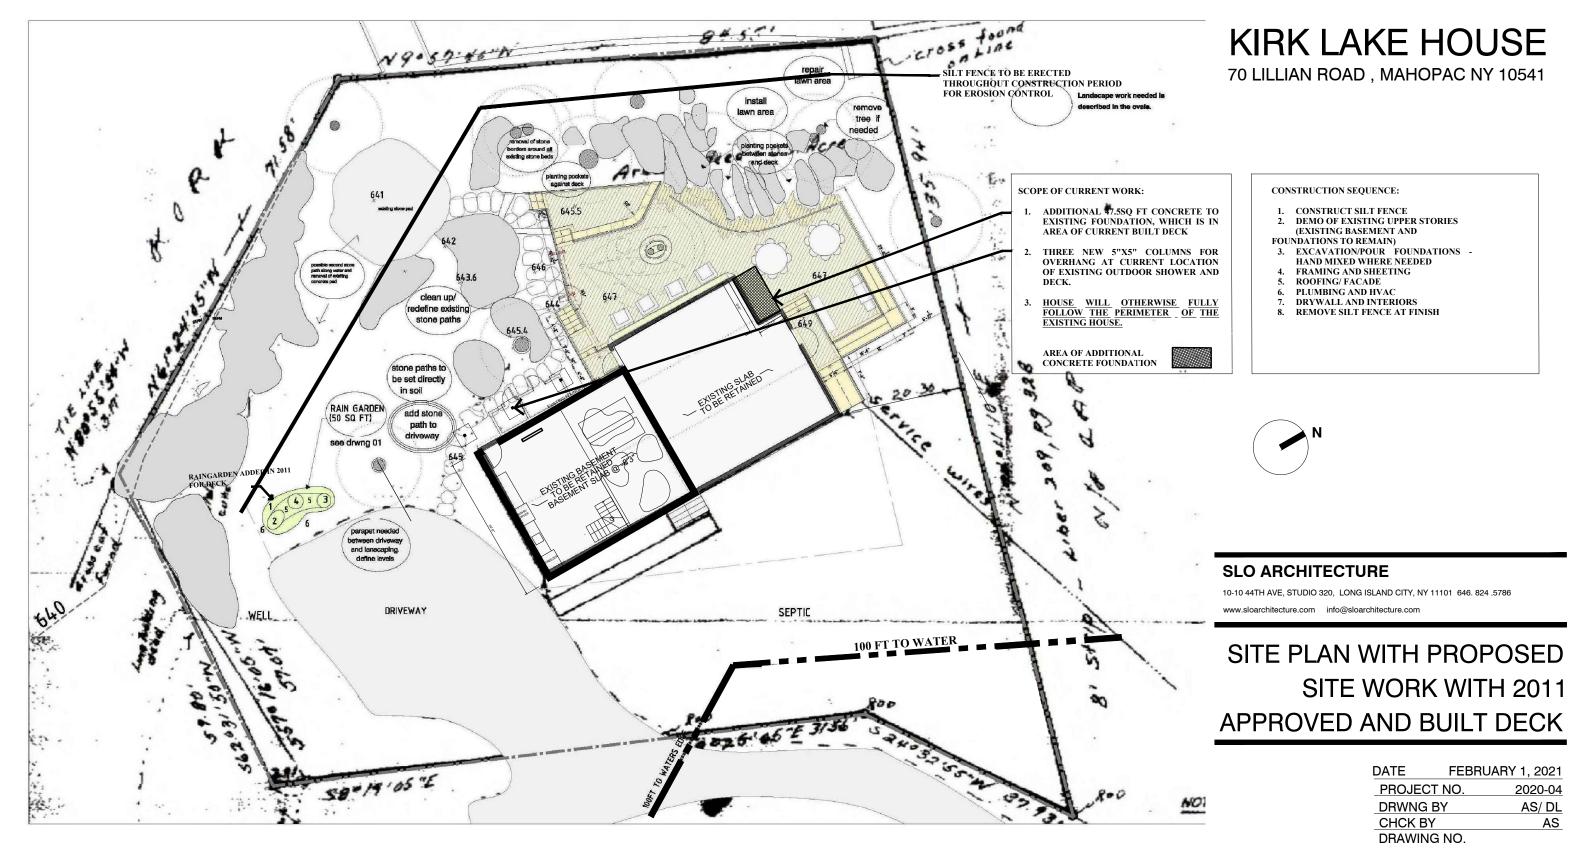

1 SITE PLAN (AT BASEMENT - LAKESIDE GROUND LEVEL) SHOWING PROPOSED WORK WITH 2011 APPROVED AND BUILT DECK SCALE 1/16" = 1' - 0"