

CRAIG PAEPRER  
*Chairman*

ANTHONY GIANNICO  
*Vice Chairman*

**BOARD MEMBERS**  
KIM KUGLER  
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ROBERT FRENKEL  
MARK PORCELLI  
VICTORIA CAUSA

**TOWN OF CARMEL**  
**PLANNING BOARD**



60 McAlpin Avenue  
Mahopac, New York 10541  
Tel. (845) 628-1500 – Ext.190  
[www.ci.carmel.ny.us](http://www.ci.carmel.ny.us)

MICHAEL CARNAZZA  
*Director of Code  
Enforcement*

RICHARD FRANZETTI, P.E.  
*Town Engineer*

PATRICK CLEARY,  
AICP, CEP, PP, LEED AP  
*Town Planner*

**PLANNING BOARD AGENDA**  
**MAY 13, 2021 – 7:00 P.M.**

**TAX MAP #   PUB. HEARING   MAP DATE   COMMENTS**

**SITE PLAN**

- |   |            |         |                   |
|---|------------|---------|-------------------|
| 1. Carmel Fire Department – 94 Gleneida Ave, Carmel | 44.14-1-24 | 4/29/21 | Amended Site Plan |
| 2. Hirsch, Stacy – 311 Drewville Road, Carmel       | 66.13-1-7  | 5/16/19 | Site Plan         |

**MISCELLANEOUS**

- |   |            |  |  |
|---|------------|--|--|
| 3. Old Forge Estates – Baldwin Place Road | 75.15-1-19 |  | Extension of Preliminary<br>Subdivision Approval |
| 4. Minutes – 04/28/21                     |            |  |  |



April 30, 2021

Town of Carmel Planning Board  
60 McAlpin Avenue  
Mahopac, New York 10541

RE: Carmel Fire Department  
94 Gleneida Avenue  
Town of Carmel  
TM# 44.14-1-24

Dear Chairman Paepre and Members of the Board:

Please find enclosed five (5) copies of the following documents in support of a site plan application revision for the above referenced project:

- Site Plans prepared by Insite Engineering, Surveying, and Landscape Architecture P.C. dated May 20, 2020 revised April 29, 2021.
- Architectural Drawings prepared by H2M Architects + Engineers dated October 20, 2020.

Since the Carmel Fire Department Site Plan Approval on November 12, 2020, the applicant has further coordinated the transformer and generator relocation in more detail with NYSEG. This final coordination was not able to occur until the Fire Department legally owned the additional area acquired by the lot line relocation. As a result of the coordination with NYSEG as well as finalizing the design of the building, the following items have changed since the site plan approval:


1. Per request of NYSEG and to assist the connection to the Bank's utility pole, a utility pole is proposed next to the utility enclosure. This has resulted in a change to the planting plan. NYSEG is requesting that limited plants be installed in this area. To maintain the intent of screening the enclosure as had been originally shown in the site plan drawings, but also comply with NYSEG regulations, the planting has been adjusted to clear the proposed pole and reduced in height in order to avoid wires. The landscaping continues to show evergreens in this area and total number of plants has remained the same.
2. There was a small reconfiguration of the building at the northern entrance. An addition of 50 square feet was added as well as an extended overhang in order to protect the entrance from incremental weather.
3. The owner would like to seal the entire parking lot; therefore, striping will be replaced in kind in the front parking lot. Total parking numbers have remained the same.
4. The erosion and sediment control plan has been supplemented with information to provide better protection and maintenance of traffic flow during construction.

We respectfully request this project be placed on the May 13, 2021 Planning Board meeting for the discussion of the attached material. Should you have any questions or comments regarding this information, please feel free to contact our office.

Very truly yours,

INSITE ENGINEERING, SURVEYING & LANDSCAPE ARCHITECTURE, P.C.



By: \_\_\_\_\_

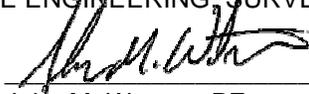  
John M. Watson, PE  
Principal Engineer

JMW/kmg

Enclosures

Cc: Michael Hengel / Carmel Fire Department  
Eric Neiler, H2M Architects

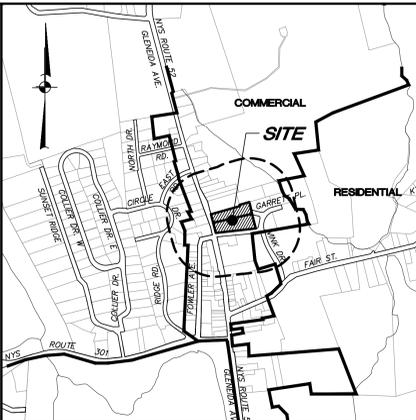
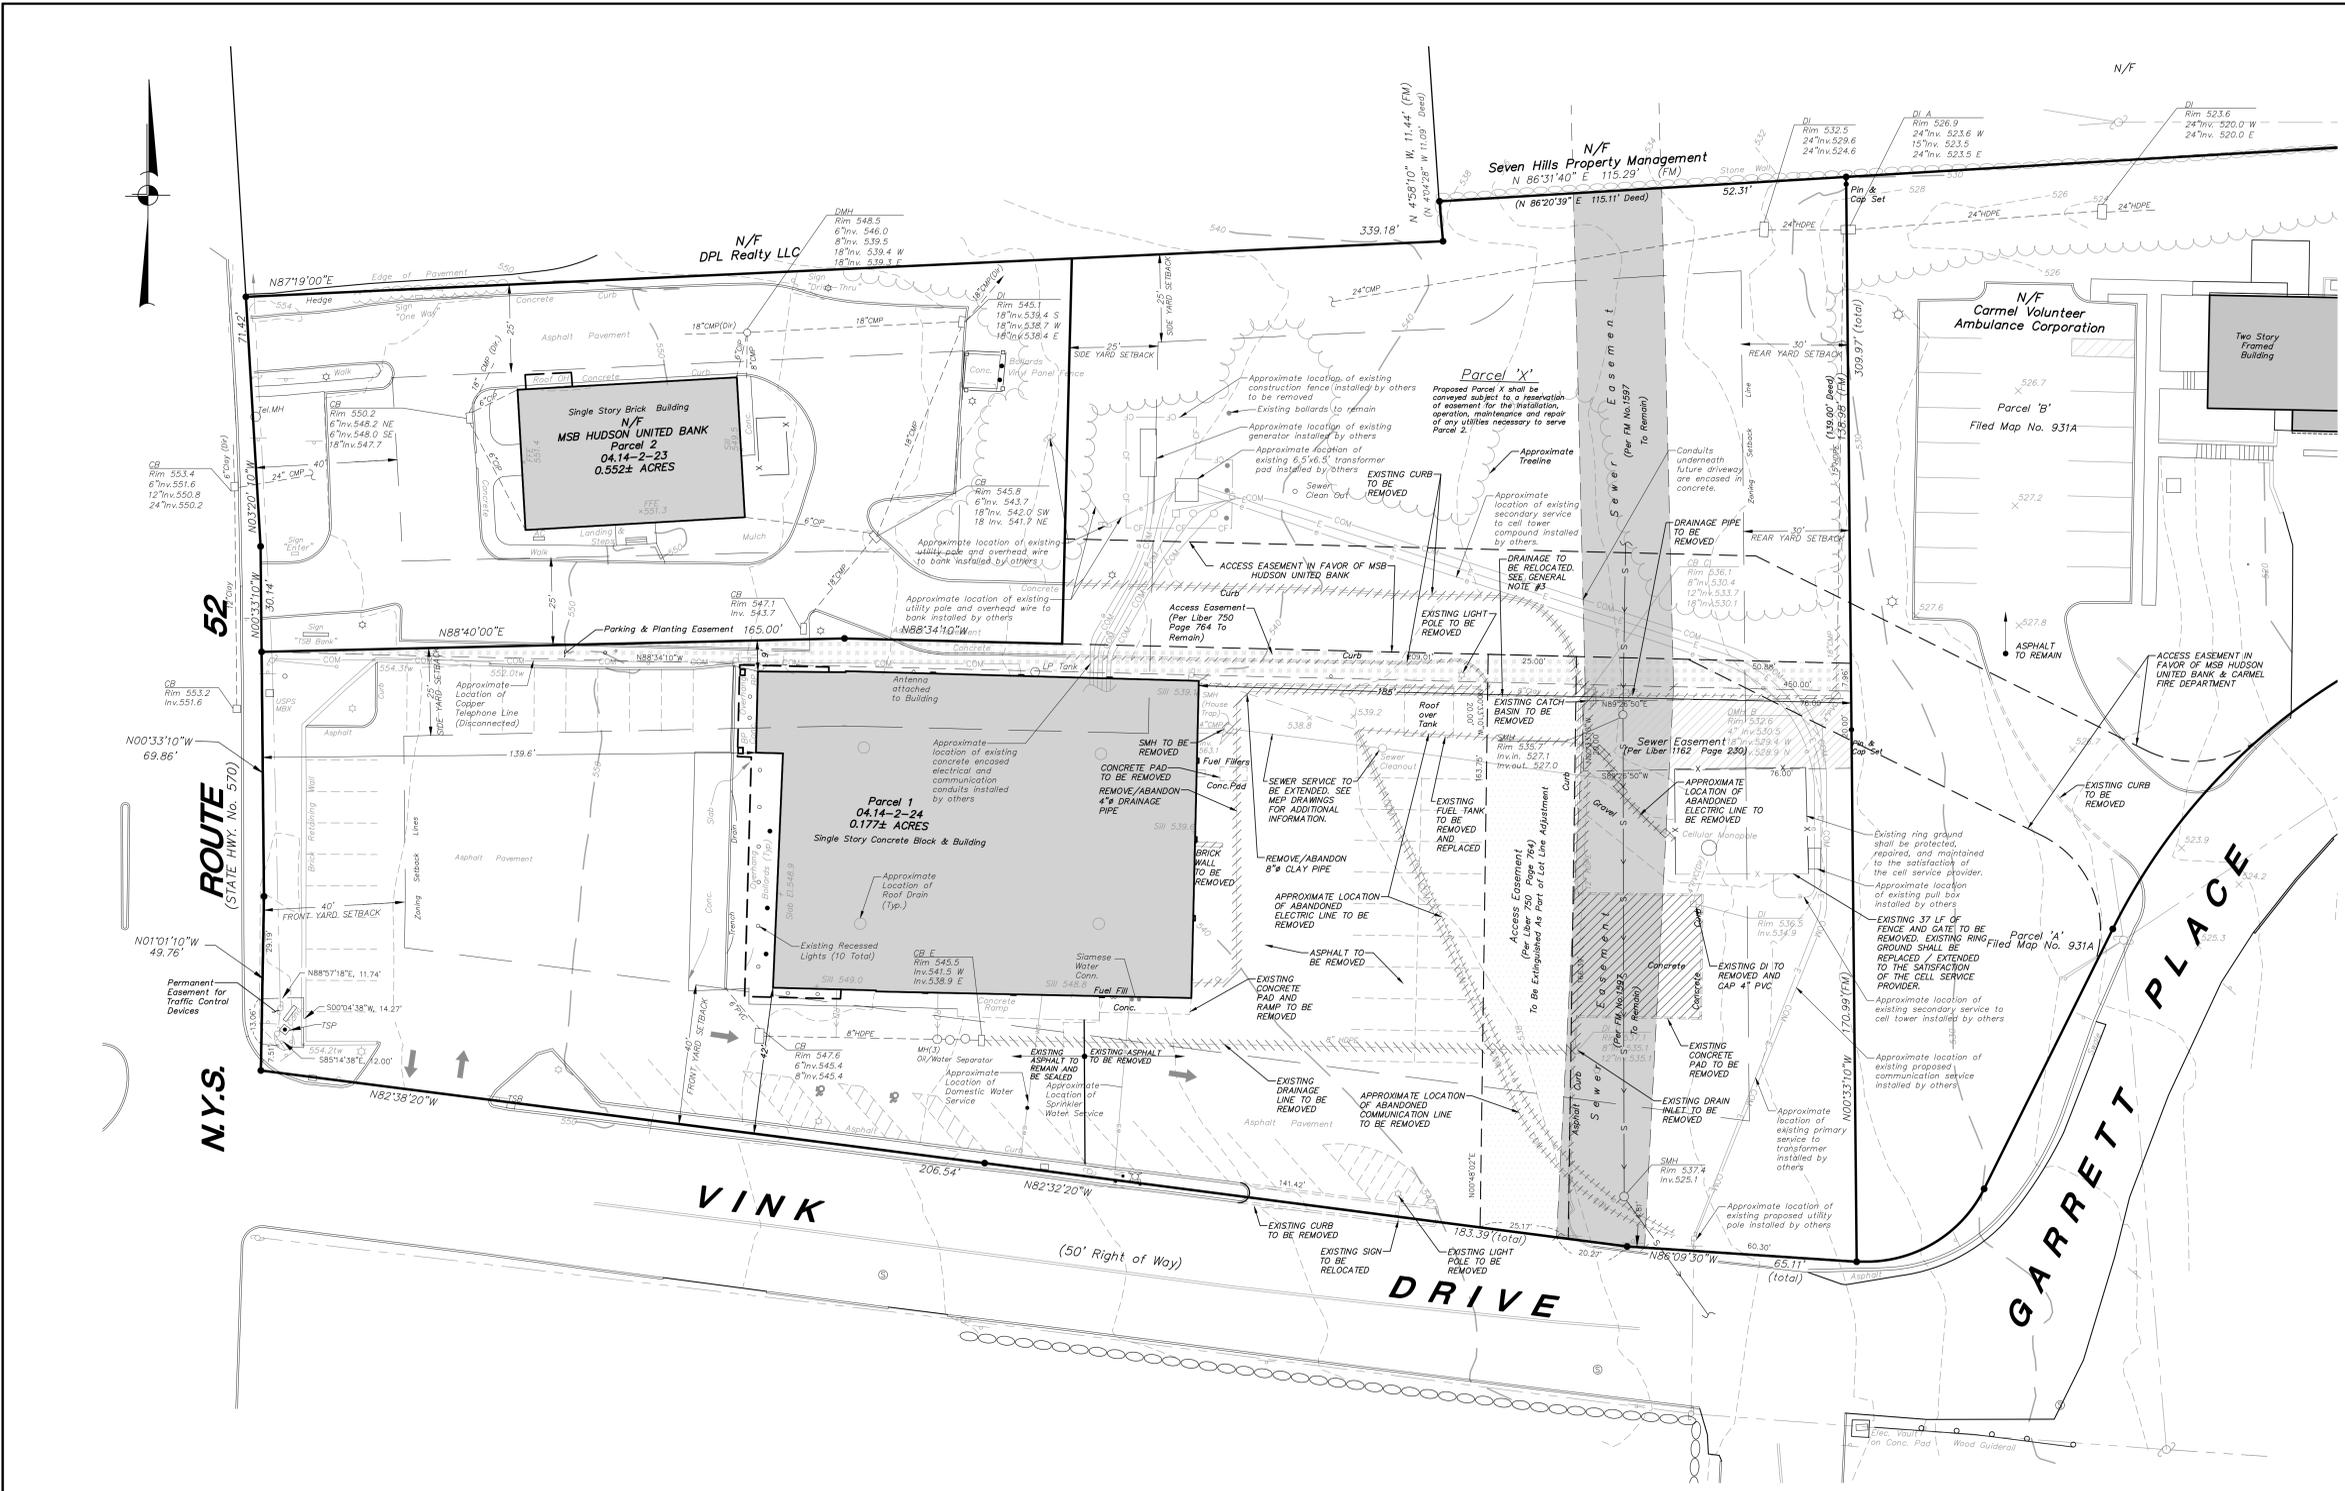


LOCATION MAP SCALE: 1" = 800'±

**OWNER/APPLICANT:**  
 CARMEL FIRE DEPARTMENT, INC.  
 94 GLENDA AVENUE  
 CARMEL, NY 12032

**SITE DATA:**  
 Zone: Commercial  
 Total Acreage: 2.2 AC  
 Tax Map No.: 44.1A-1-24


- GENERAL NOTES:**
- Location map boundary information shown hereon is taken from the Putnam County Tax Map.
  - Property boundary, site features and existing topography shown hereon is based upon fieldwork performed by Insite Engineering, Surveying & Landscape Architecture, P.C., completed December 13, 2019. Elevations shown hereon are in NAVD83. The contour interval is 2'.
  - Contractor to determine roof drain and footing drain locations and relocate as required.
  - All electrical work shown associated with the generator and transformer relocation is currently in progress and shown on drawings as an existing condition.

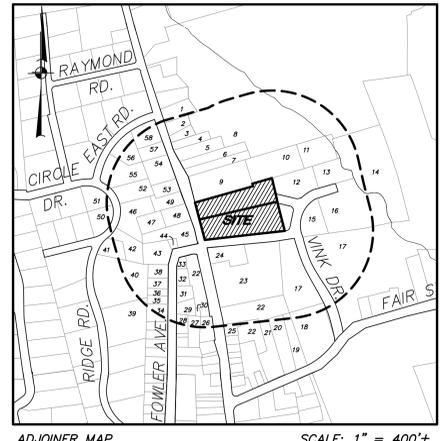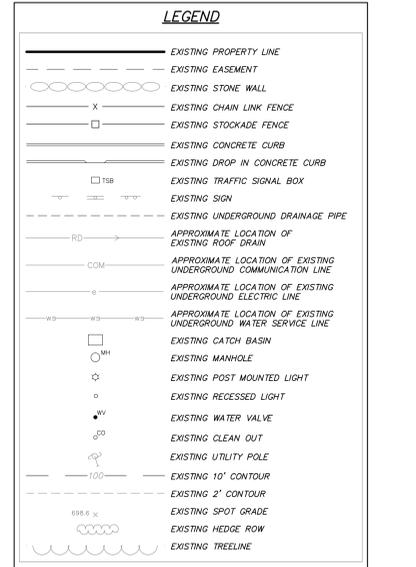

ADJOINER MAP SCALE: 1" = 400'±

**500' ADJOINERS:**  
 TOWN OF CARMEL

- |                                  |                                     |
|----------------------------------|-------------------------------------|
| 1. Rodolfo A Roque               | 30. Carmel Board of Fire Commission |
| 2. Susan P Alm                   | 31. Longview Realty Corp            |
| 3. Marcel Carrillo               | 32. Maria J Casti                   |
| 4. Louis Scifani                 | 33. Mary J Kipp                     |
| 5. Joyce McGlasson               | 34. Augusto Sacchetti               |
| 6. Rick Montes                   | 35. Marlon Ramlogan                 |
| 7. Edward M Schaffer             | 36. Kevin D O'Donnell               |
| 8. Rt 52 Housing Devol Fund Co   | 37. JRP Associates LLC              |
| 9. DPL Realty, LLC               | 38. Ernest Fernandez                |
| 10. Seven Hills Property Mgmt    | 39. David Chau                      |
| 11. Michael Yodanis              | 40. Yocasta Doss                    |
| 12. Carmel Vol Ambulance Corp    | 41. Allan J Eyring                  |
| 13. John Mitchell                | 42. Michelle Hides                  |
| 14. Hugo Hayes LLC               | 43. BND Fowler Property, LLC        |
| 15. Harman Holdings Ltd          | 44. David Radovich                  |
| 16. Harman Holdings Ltd          | 45. Foster Ave Corp                 |
| 17. Main Woodland Trail          | 46. William Rippey                  |
| 18. United States Postal Service | 47. Richard McGlasson               |
| 19. Rancic Enterprises Corp      | 48. 91 Glenside LLC                 |
| 20. 17 Fair St, LLC              | 49. 91 Glenside LLC                 |
| 21. Wenco Properties Corp        | 50. Josephine Alessi                |
| 22. Mt Carmel Baptist Church     | 51. Eleanor Vitaldi                 |
| 23. Kelly Cemetery Inc           | 52. James P McGuire                 |
| 24. 90 Glenside Ave Corp         | 53. P & R Estate Corp               |
| 25. Mt Carmel Baptist Church     | 54. 99 Glenside Avenue LLC          |
| 26. Wayne Ryder                  | 55. Carla D Taylor                  |
| 27. Robert A Hall                | 56. Philip F Ford                   |
| 28. Peter Falbach                | 57. Wayne Ryder                     |
| 29. Robert Hall                  | 58. 105 Glenside Ave Corp.          |

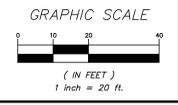

NO.	DATE	REVISION	BY
4	4-29-21	PLANNING BOARD SUBMISSION	MEU
3	10-8-20	PLANNING BOARD SUBMISSION	ERA
2	8-7-20	PLANNING BOARD SUBMISSION	KMG
1	7-17-20	PLANNING BOARD SUBMISSION	ERA

**INSITE**  
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 LANDSCAPE ARCHITECTURE, P.C.

3 Garrett Place  
 Carmel, NY 12032  
 (845) 225-9690  
 (845) 225-9717 fax  
 www.insite-eng.com

PROJECT: **CARMEL FIRE DEPARTMENT**  
 94 GLENDA AVENUE, CARMEL, PUTNAM COUNTY, NEW YORK

DRAWING: **EXISTING CONDITIONS & REMOVALS PLAN**

PROJECT NUMBER: 19135.100 PROJECT MANAGER: J.M.W. DRAWING NO.: SHEET  
 DATE: 5-20-20 DRAWN BY: C.B.Z. BY: EX-1  
 SCALE: 1" = 20' CHECKED BY: K.M.G. 10

ALTERATION OF THIS DOCUMENT, UNLESS UNDER THE DIRECTION OF A LICENSED PROFESSIONAL ENGINEER, IS A VIOLATION OF SECTION 2209 OF ARTICLE 145 OF THE EDUCATION LAW.

PLANT LIST (BY OWNER)				
QUANTITY	KEY	BOTANICAL/COMMON NAME	SIZE	ROOT/SPACING
11	TD	Thuja occidentalis "Emerald Green" / Emerald Green Arborvitae	6"-7"	B&B
8	IN	Ilex Nelloe R. Stevens / Nelloe R. Stevens' Holly	5'-6"	B&B
4	TC	Thuja occidentalis "Golden Globe" / Golden Globe Arborvitae	18"-24"	#3 CONT.
11	RC	Rhododendron "Chionoides" / Chionoides Rhododendron	24"-30"	#5 CONT.

LEGEND	
	EXISTING PROPERTY LINE
	EXISTING EASEMENT
	EXISTING STONE WALL
	EXISTING CHAIN LINK FENCE
	EXISTING STOCKADE FENCE
	EXISTING CONCRETE CURB
	EXISTING DROP IN CONCRETE CURB
	EXISTING SIGN
	EXISTING HEDGE ROW
	EXISTING TREELINE
	EXISTING POST MOUNTED LIGHT
	EXISTING RECESSED LIGHT
	EXISTING UTILITY POLE
	PROPOSED # OF STALLS TO BE STRIPED
	PROPOSED CONCRETE CURB
	PROPOSED PAINTED HANDICAP PARKING SYMBOL
	PROPOSED STRIPED ISLAND
	PROPOSED TRAFFIC SIGN
	PROPOSED POLE MOUNTED LIGHT
	PROPOSED BUILDING MOUNTED LIGHT
	PROPOSED LANDSCAPING

**APPARATUS BAY ENTRANCE NOTES:**

- A member of the Carmel Fire Department will be present when a fire apparatus returns and enters the apparatus bay in order to direct non-fire department traffic generated by the Bank Parcel.

SIGN DATA TABLE				
LOCATION NO.	TEXT	M.U.T.C.D. NUMBER	SIZE OF SIGN (S.F.)	DESCRIPTION
1		NY R7-B*	12" x 18"	Green on White Blue Symbol
		R7-BP	12" x 6"	Green on White
2		R7-1	12" x 18"	Red on White
3		R5-1C	30" x 30"	White on Red

**C ZONE REQUIREMENTS:**

	Requires/Permit/Use	Existing	Proposed
Minimum Lot Area:	40,000 SF	94,830 SF	94,830 SF
Minimum Lot Width:	200'	261'±	261'±
Minimum Lot Depth:	200'	450'±	450'±
Minimum Road Frontage:	100'	574.7'±	574.7'±
Minimum Yard Setbacks:			
Front:	40'	42'±	41'±
Side:	25'	8.9'±*	8.9'±*
Rear:	30'	185'±	78'±
Maximum Building Height:	35'	Less than 35'	Less than 35'
Minimum Building Floor Area:	5,000 SF	>5,000 SF±	26,900 SF±
Maximum Building Coverage:	30%	14%±**	22%±**

- \* Pre-existing nonconforming condition
- \*\* Includes a 775 sf allocation for structures within the cellular tower facility.
- \*\*\* The applicant was granted a variance for a driveway less than 24' (§ 145-42 D) by the Town of Carmel Zoning Board of Appeals on August 27, 2020. The variance was granted for a 20' driveway.

**PARKING SUMMARY**

REQUIRED:	PROVIDED:
FIRE DEPARTMENT SPACES (CALCULATED AS WHOLESALE, WAREHOUSE, STORAGE, HEAVY COMMERCIAL ESTABLISHMENTS) 12,524 S.F. @ 1 SPACE/1,000 S.F. = 13 REQUIRED	14 PROVIDED
6,976 S.F. OF OFFICE SPACE @ 1 SPACE/200 S.F. = 35 REQUIRED	35 PROVIDED
* 2,400 S.F. OF APPARATUS BAY AND NOTE INCLUDED PARKING CALCULATIONS	
TOTAL PARKING SPACE REQUIRED = 48 REQUIRED	TOTAL PARKING SPACE PROVIDED = 48 PROVIDED

**OUTDOOR TRAINING NOTES:**

- Outdoor training will occur offsite at the county fire training center. If outdoor training does occur on site, it will occur nights and weekends when possible, and training area will be closed off to preserve necessary vehicular circulation.

**GENERAL PLANTING NOTES:**

- All proposed planting beds to receive a 12" min. depth of topsoil. Soil amendments and fertilizer application rates shall be determined based on specific testing of topsoil material.
- Any new soils added will be amended as required by results of soil testing and placed using a method that will not cause compaction.
- All plant material to be nursery grown.
- Plants shall conform with ANSI Z60.1 American Standard for Nursery Stock in all ways including dimensions.
- Plant material shall be taken from healthy nursery stock.
- All plants shall be grown under climate conditions similar to those in the locality of the project.
- Plants shall be planted in all locations designed on the plan or as staked in the field by the Landscape Architect.
- The location and layout of landscape plants shown on the site plan shall take precedence in any discrepancies between the quantities of plants shown on the plans and the quantity of plants in the Plant List.
- Provide a 3" layer of shredded pine bark mulch (or as specified) over entire watering source of all tree pits or over entire planting bed. Do not place mulch within 3" of tree or shrub trunks.
- All landscape plantings shall be maintained in a healthy condition at all times. Any dead or diseased plants shall immediately be replaced "in kind" by the contractor (during warranty period) or project owner.
- All plantings shall be installed per § 142 of the Town of Carmel Town Code. In addition, plantings shall be verified by the Town of Carmel Wetland Inspector.

4	4-29-21	PLANNING BOARD SUBMISSION	MEU
3	10-8-20	PLANNING BOARD SUBMISSION	ERA
2	8-7-20	PLANNING BOARD SUBMISSION	KMG
1	7-17-20	PLANNING BOARD SUBMISSION	ERA
NO.	DATE	REVISION	BY



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PROJECT: **CARMELO FIRE DEPARTMENT**  
94 GLENEDA AVENUE, CARMELO, PUTNAM COUNTY, NEW YORK

DRAWING: **LAYOUT AND LANDSCAPE PLAN**

PROJECT NUMBER: 19135.100 PROJECT MANAGER: J.M.W.  
DATE: 5-20-20 DRAWN BY: C.B.Z.  
SCALE: 1" = 20' CHECKED BY: K.M.G.

DRAWING NO. SHEET: **SP-1** 2/10

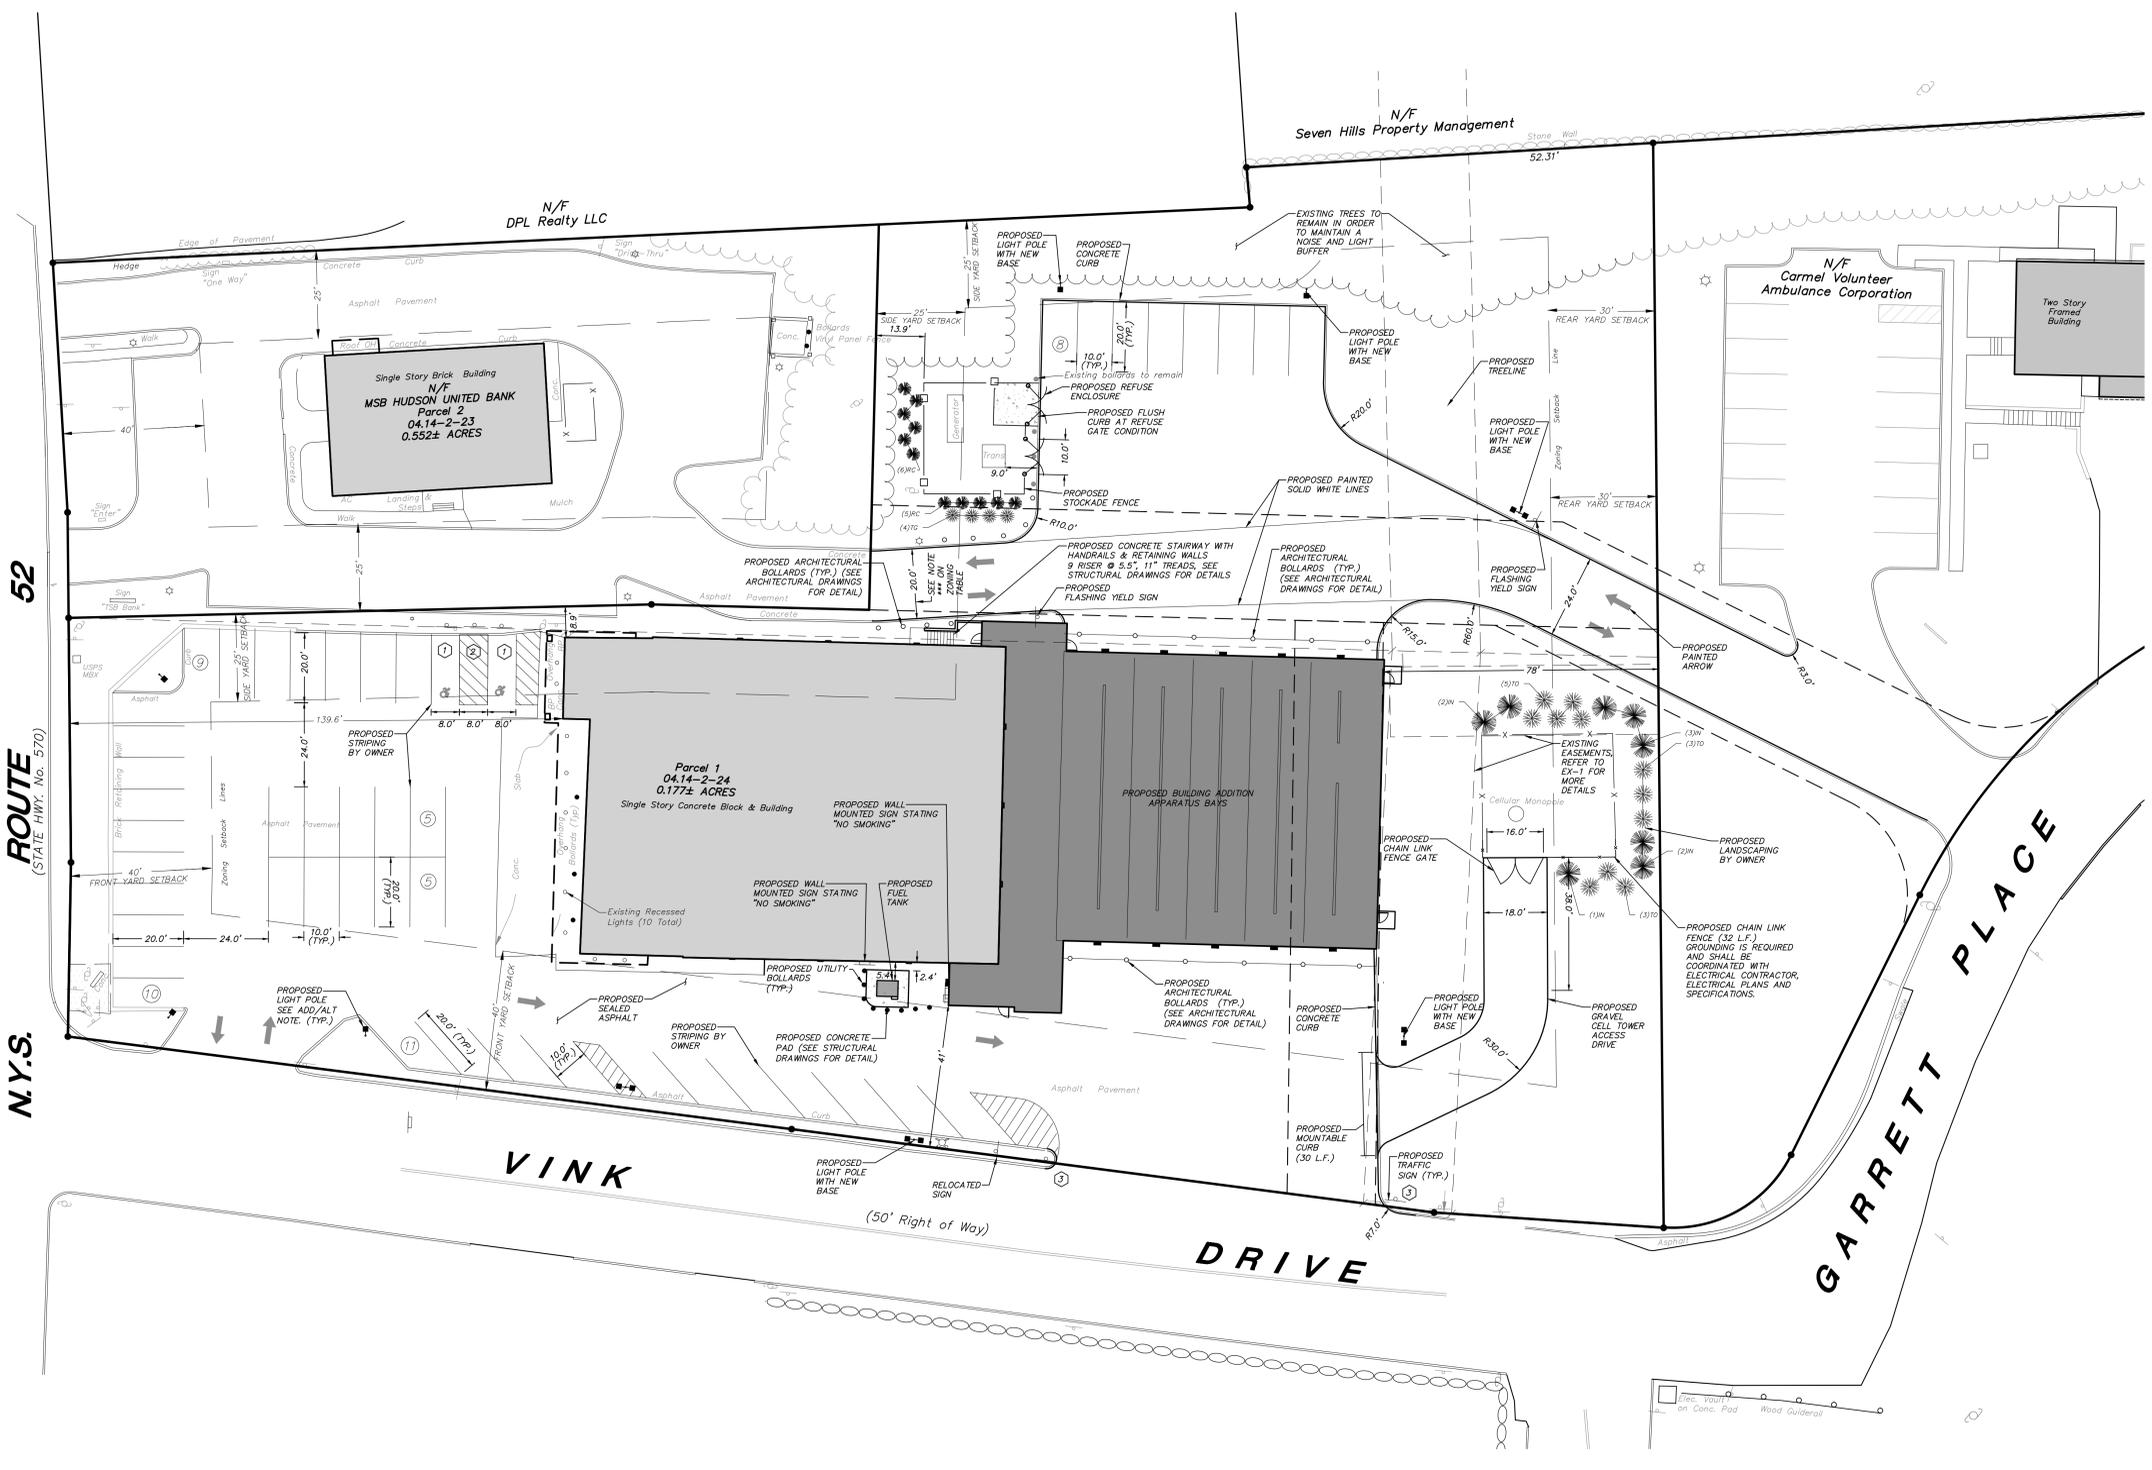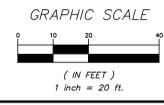

ALTERATION OF THIS DOCUMENT, UNLESS UNDER THE DIRECTION OF A LICENSED PROFESSIONAL ENGINEER, IS A VIOLATION OF SECTION 2209 OF ARTICLE 145 OF THE EDUCATION LAW.

**EARTHWORK SUMMARY:**


CUT: 280 C.Y.  
 FILL: 1,760 C.Y.  
 TOTAL: 1,480 C.Y. (FILL)

**EARTHWORK NOTES:**

1. THE EARTHWORK CALCULATIONS ILLUSTRATES THE CUTS AND FILLS BASED ON THE DIFFERENCE BETWEEN THE EXISTING AND PROPOSED FINISHED GRADES.
2. ALL VOLUMES WERE ROUNDED TO THE NEAREST 10 CUBIC YARDS.
3. FACTORS FOR SWELL OR COMPACTION WERE NOT APPLIED IN THIS ANALYSIS.
4. THIS ANALYSIS IS PRELIMINARY AND PROVIDED FOR PERMITTING ONLY. THESE NUMBERS SHOULD NOT BE USED BY A CONTRACTOR FOR BIDDING PURPOSES. THE CONTRACTOR IS RESPONSIBLE FOR PROVIDING THEIR OWN EARTHWORK ANALYSIS.

**LEGEND**

	EXISTING PROPERTY LINE
	EXISTING EASEMENT
	EXISTING STONE WALL
	EXISTING CHAIN LINK FENCE
	EXISTING STOCKADE FENCE
	EXISTING CONCRETE CURB
	EXISTING DROP IN CONCRETE CURB
	EXISTING TRAFFIC SIGNAL BOX
	EXISTING SIGN
	EXISTING UNDERGROUND DRAINAGE PIPE
	EXISTING CATCH BASIN
	EXISTING MANHOLE (Type unidentified)
	EXISTING POST MOUNTED LIGHT
	EXISTING RECESSED LIGHT
	EXISTING WATER VALVE
	EXISTING CLEAN OUT
	EXISTING UTILITY POLE
	EXISTING 10' CONTOUR
	EXISTING 2' CONTOUR
	EXISTING SPOT GRADE
	PROPOSED 10' CONTOUR
	PROPOSED 2' CONTOUR
	PROPOSED SPOT ELEVATION
	PROPOSED TOP OF CURB & BOTTOM OF CURB ELEVATIONS
	PROPOSED DRAINAGE MANHOLE
	PROPOSED DRAIN INLET (DI) OR CATCH BASIN (CB)
	PROPOSED 12 HOPE DRAINAGE PIPE
	PROPOSED 4" PVC SDR 35 SEWER SERVICE LINE WITH CLEANOUT
	PROPOSED 8" DIAMETER PVC SDR 35 ROOF DRAIN
	PROPOSED COMMUNICATIONS SERVICE
	PROPOSED PRIMARY ELECTRICAL SERVICE
	PROPOSED SECONDARY ELECTRICAL SERVICE
	PROPOSED OVERHEAD WIRE
	PROPOSED UTILITY POLE

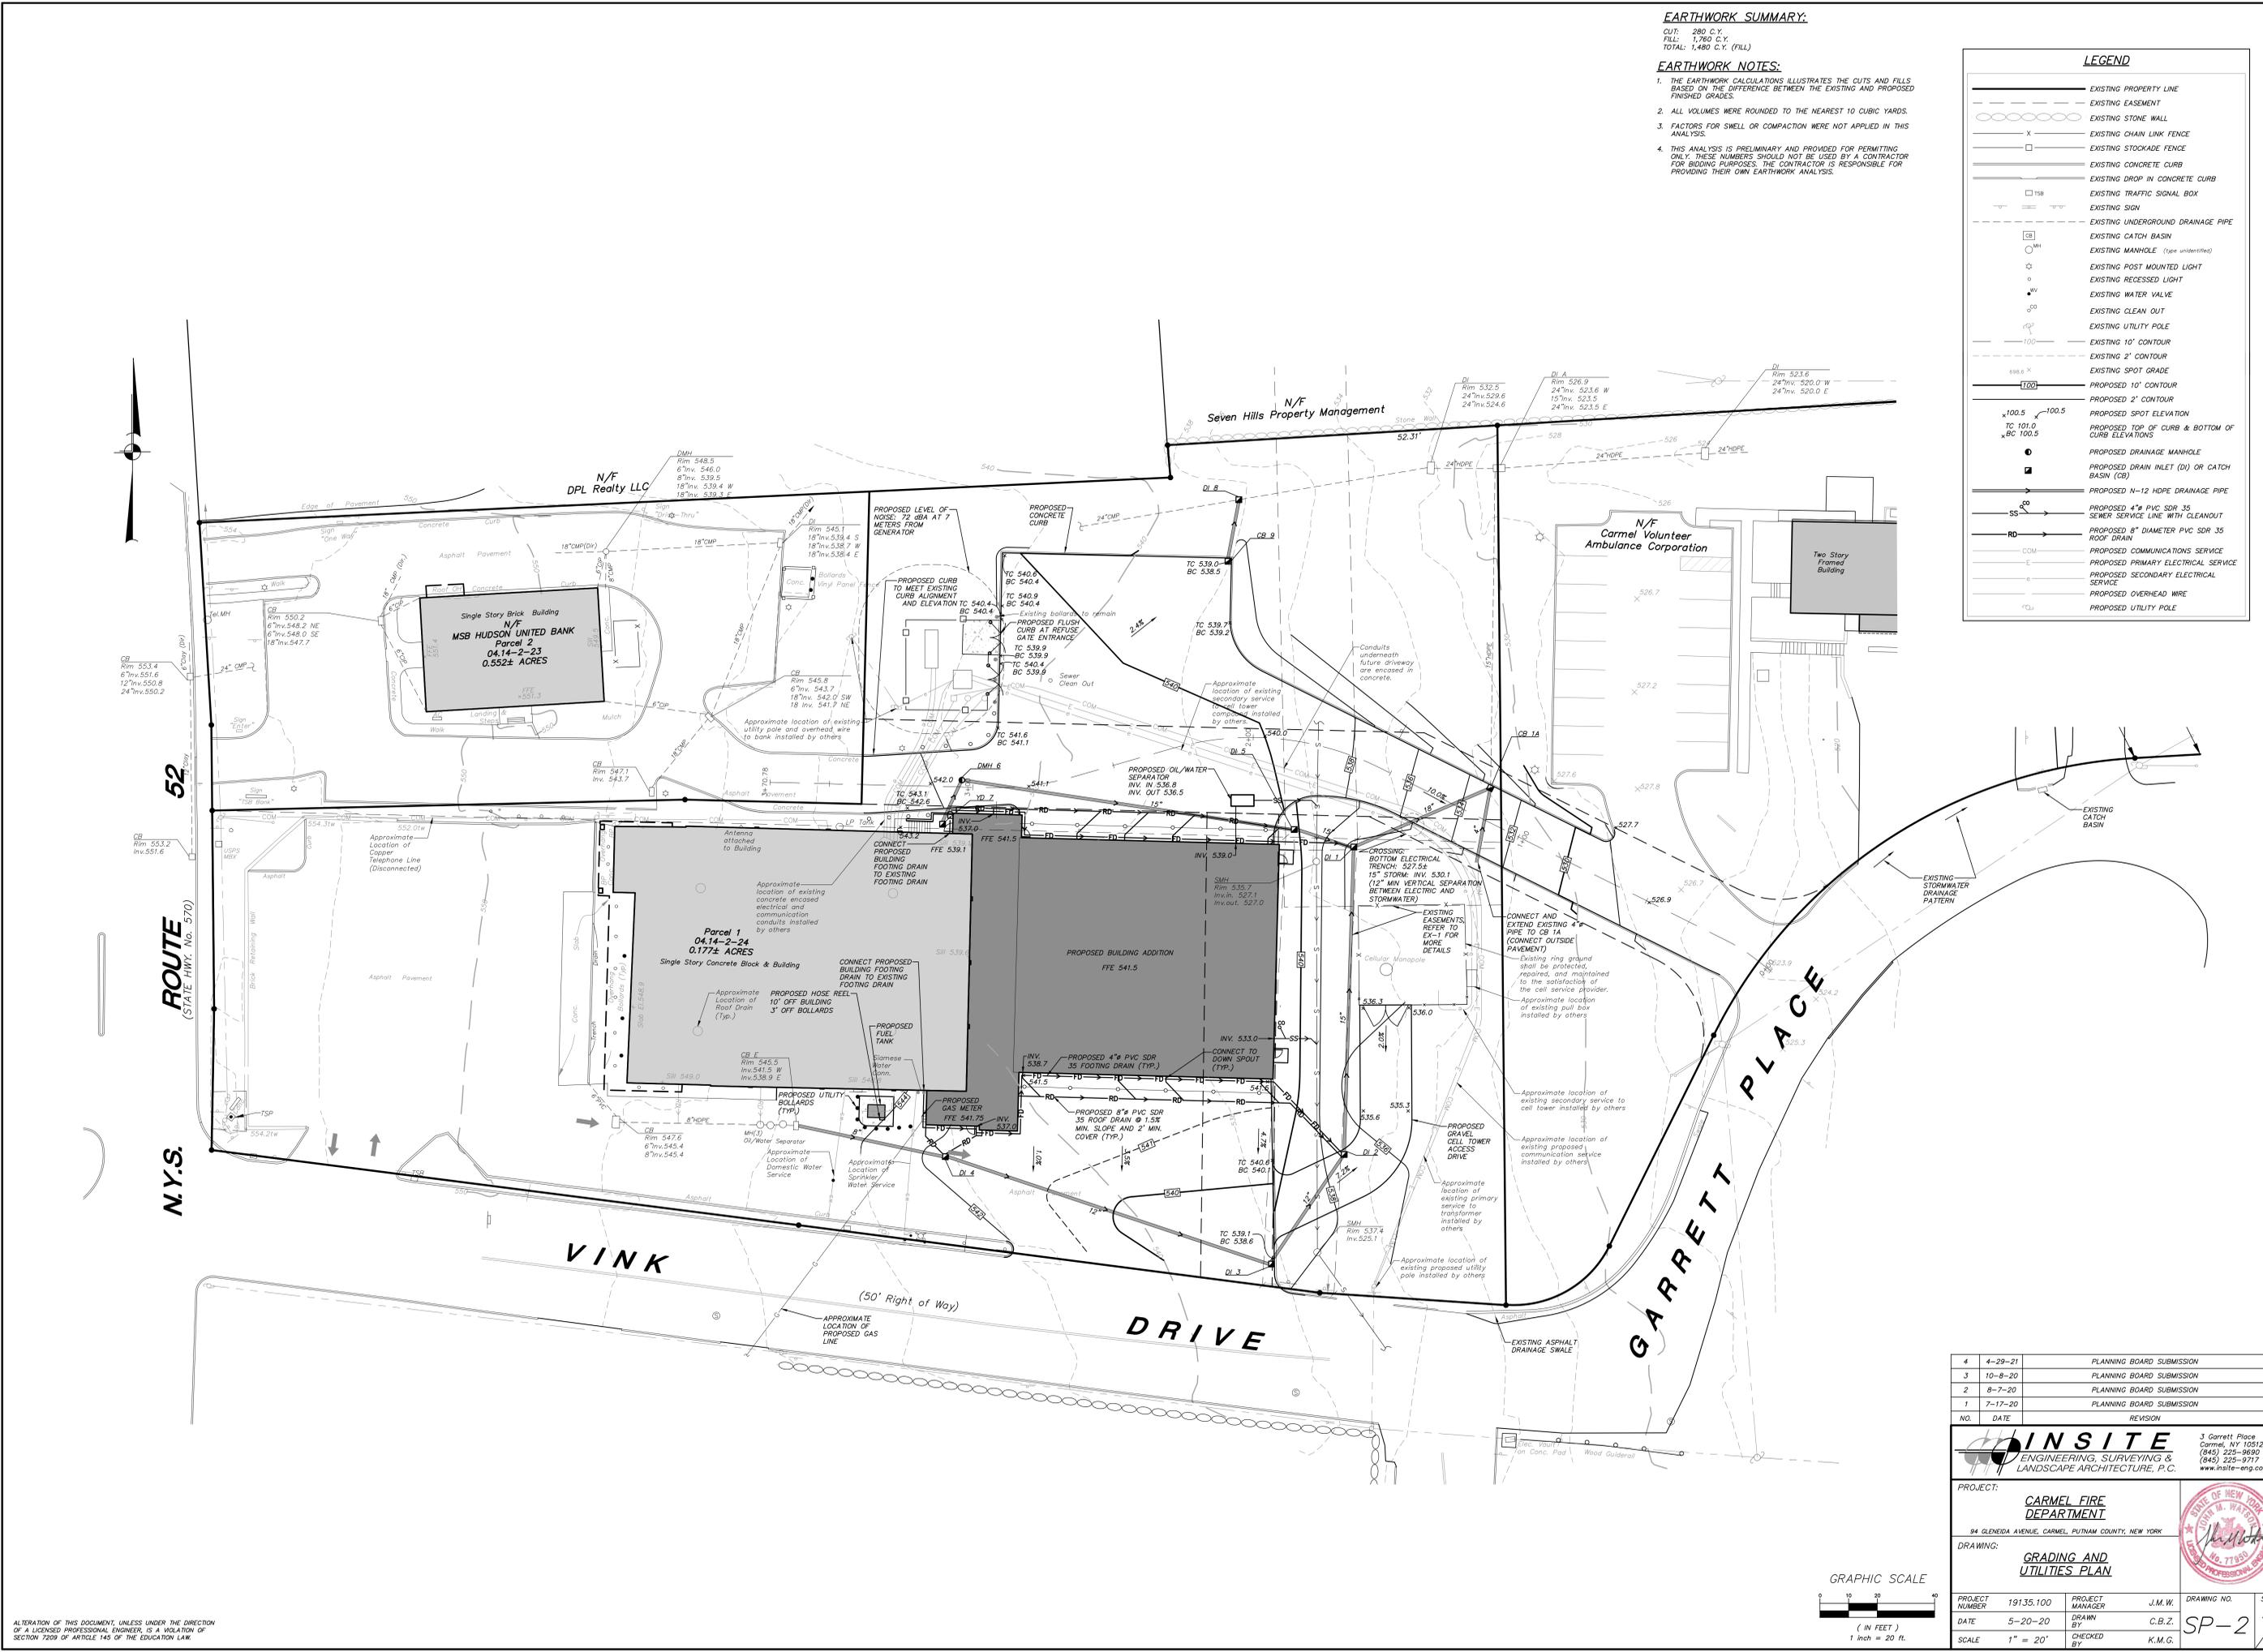

4	4-29-21	PLANNING BOARD SUBMISSION	MEU
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NO.	DATE	REVISION	BY


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 (845) 225-9690  
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PROJECT: **CARMELO FIRE DEPARTMENT**  
 94 GLENEDA AVENUE, CARMELO, PUTNAM COUNTY, NEW YORK

DRAWING: **GRADING AND UTILITIES PLAN**

PROJECT NUMBER	19135.100	PROJECT MANAGER	J.M.W.	DRAWING NO.	SHEET
DATE	5-20-20	DRAWN BY	C.B.Z.		3
SCALE	1" = 20'	CHECKED BY	K.M.G.		10



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**EROSION AND SEDIMENT CONTROL MAINTENANCE SCHEDULE**

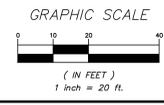PRACTICE	MONITORING REQUIREMENTS			MAINTENANCE REQUIREMENTS	
	DAILY	WEEKLY	AFTER RAINFALL	DURING CONSTRUCTION	AFTER CONSTRUCTION
SILT FENCE BARRIER	-	Inspect	Inspect	Clean/Replace	Remove
STABILIZED CONSTRUCTION ENTRANCE	Inspect	-	Inspect	Clean/Replace Stone and Fabric	Remove
INLET PROTECTION	-	Inspect	Inspect	Clean/Repair/Replace	Remove
DUST CONTROL	Inspect	-	Inspect	Mulching/Spraying Water	N/A
VEGETATIVE ESTABLISHMENT	-	Inspect	Inspect	Water/Reseed/Remulch	Reseed to 80% Coverage
SOIL STOCKPILES	-	Inspect	Inspect	Mulching/Silt Fence Repair	Remove
CONCRETE DRAINAGE STRUCTURES	-	Inspect	Inspect	Clean Sumps/Remove Debris/Repair/Replace	See Permanent Stormwater Facilities Maintenance Schedule on Drawing D-10
DRAINAGE PIPES	-	Inspect	Inspect	Clean/Repair	
ACCESS ROAD / PAVEMENT	-	Inspect	Inspect	Clean	Clean

\* Permanent vegetation is considered stabilized when 80% of the plant density is established. Erosion control measures shall remain in place until all disturbed areas are permanently stabilized.

**CONSTRUCTION SEQUENCE:**  
(Total Area of Disturbance = 43,267 SF±)

- Schedule Pre-Construction meeting with Site Engineer / Town.
- Install silt fence and stabilized construction entrance as shown on plans in accordance with the plan and detail. Install orange construction fence in locations shown on the plan.
- Begin clearing and grubbing operations associated with the site work improvements.
- Begin building addition, stormwater system and sewer connection construction.
- Upon completion of stormwater system, connect roof leader drains.
- Install subbase and pavement for parking lot and driveway areas.
- Upon completion of all work, stabilize disturbed areas in accordance with the Sediment and Erosion Control Notes. Permanent stabilization is achieved when 80% of the plant/grass density is established.
- Once the site has received final stabilization, remove all temporary sediment and erosion control facilities.

**LEGEND**


(---)	EXISTING PROPERTY LINE
(---)	EXISTING EASEMENT
(---)	EXISTING STONE WALL
(X)	EXISTING CHAIN LINK FENCE
(---)	EXISTING STOCKPADE FENCE
(---)	EXISTING CONCRETE CURB
(---)	EXISTING DROP IN CONCRETE CURB
(---)	EXISTING TRAFFIC SIGNAL BOX
(---)	EXISTING SIGN
(---)	EXISTING UNDERGROUND DRAINAGE PIPE
(---)	EXISTING CATCH BASIN
(---)	EXISTING MANHOLE (Type indicated)
(---)	EXISTING POST MOUNTED LIGHT
(---)	EXISTING RECESSED LIGHT
(---)	EXISTING WATER VALVE
(---)	EXISTING CLEAN OUT
(---)	EXISTING UTILITY POLE
(---)	EXISTING 10' CONTOUR
(---)	EXISTING 2' CONTOUR
(---)	EXISTING SPOT GRADE
(---)	PROPOSED 10' CONTOUR
(---)	PROPOSED 2' CONTOUR
(---)	PROPOSED SPOT ELEVATION
(---)	PROPOSED TOP OF CURB & BOTTOM OF CURB ELEVATIONS
(---)	PROPOSED DRAIN INLET (DI) OR CATCH BASIN (CB) WITH INLET PROTECTION
(---)	PROPOSED SILT FENCE
(---)	PROPOSED CONSTRUCTION FENCE
(---)	PROPOSED TEMPORARY SOIL STOCKPILE
(---)	PROPOSED STABILIZED CONSTRUCTION ENTRANCE

**EROSION & SEDIMENT CONTROL NOTES:**

- The owner's field representative (O.F.R.) will be responsible for the implementation and maintenance of erosion and sediment control measures on this site prior to and during construction.
- All construction activities involving the removal or disposition of soil are to be provided with appropriate protective measures to minimize erosion and contain sediment disposition within. Minimum soil erosion and sediment control measures shall be implemented as shown on the plans and shall be installed in accordance with "New York Standards and Specifications For Erosion and Sediment Control," latest edition.
- Wherever feasible, natural vegetation should be retained and protected. Disturbance shall be minimized in the areas required to perform construction. No more than 5 acres of unprotected soil shall be exposed at any one time.
- When land is exposed during development, the exposure shall be kept to the shortest practical period of time. In the areas where soil disturbance activity has temporarily or permanently ceased, the application of soil stabilization measures must be initiated by the end of the next business day and completed within seven (7) days from the date the current soil disturbance activity ceased. Disturbance shall be minimized to the areas required to perform construction.
- Silt fence shall be installed as shown on the plans prior to beginning any clearing, grubbing or earthwork.
- All topsoil to be stripped from the area being developed shall be stockpiled and immediately seeded for temporary stabilization. Ryegrass (annual or perennial) at a rate of 30 lbs. per acre shall be used for temporary seeding in spring, summer or early fall. "Aristoak" Winter Rye (cereal rye) shall be used for temporary seeding in late fall and winter.
- Any disturbed areas not subject to further disturbance or construction traffic, permanent or temporary, shall have soil stabilization measures initiated for permanent vegetation cover in combination with a suitable mulch within 1 business day of final grading. All seeded areas to receive a minimum 4" topsoil (from stockpile area) and be seeded and mulched as follows:
  - Seed mixture to be planted between March 21 and May 20, or between August 15 and October 15 as directed by project representative at a rate of 100 pounds per acre in the following proportions:
    - Kentucky Bluegrass 30%
    - Creeping Red Fescue 40%
    - Perennial Ryegrass 20%
    - Annual Ryegrass 20%
  - Mulch: Salt hay or small grain straw applied at a rate of 90 lbs./1000 S.F. or 2 tons/acre, to be applied and anchored according to "New York Standards and Specifications For Erosion and Sediment Control," latest edition.
- Grass seed mix may be applied by either mechanical or hydroseeding methods. Seeding shall be performed in accordance with the current edition of the "NYSDOT Standard Specification, Construction and Materials, Section 610-1.02, Method No. 1." Hydroseeding shall be performed using materials and methods as approved by the site engineer.
- Cut or fill slopes steeper than 3:1 shall be stabilized immediately after grading with Curlex J Single Net Erosion Control Blanket, or approved equal.
- Paved roadways shall be kept clean at all times.
- The site shall at all times be graded and maintained such that all stormwater runoff is diverted to soil erosion and sediment control facilities.
- All storm drainage outlets shall be stabilized, as required, before the discharge points become operational.
- Stormwater from disturbed areas must be passed through erosion control barriers before discharge beyond disturbed areas or discharged into other drainage systems.
- Erosion and sediment control measures shall be inspected and maintained on a daily basis by the O.F.R. to insure that channels, temporary and permanent ditches and pipes are clear of debris, that embankments and berms have not been breached and that all straw bales and silt fences are intact. Any failure of erosion and sediment control measures shall be immediately repaired by the contractor and inspected for approval by the O.F.R. and/or site engineer.
- Dust shall be controlled by sprinkling or other approved methods as necessary, or as directed by the O.F.R.
- Cut and fills shall not endanger adjoining property, nor divert water onto the property of others.
- All fills shall be placed and compacted in 6" lifts to provide stability of material and to prevent settlement.
- The O.F.R. shall inspect downstream conditions for evidence of sedimentation on a weekly basis and after rainstorms.
- As warranted by field conditions, special additional erosion and sediment control measures, as specified by the site engineer and/or the Town Engineer shall be installed by the contractor.
- Erosion and sediment control measures shall remain in place until all disturbed areas are suitably stabilized.

**REQUIRED SWPPP CONTENTS PER GP-0-20-001:**

- Pursuant to the NYSDEC "SPDES General Permit for Stormwater Discharges from Construction Activity" (GP-0-20-001), all Stormwater Pollution Prevention Plans (SWPPP) shall include erosion and sediment control practices designed in conformance with the most current version of the technical standard, "New York Standards and Specifications for Erosion and Sediment Control." Where erosion and sediment control practices are not designed in conformance with this technical standard, the owner or operator must demonstrate equivalence to the technical standard. The following list of required SWPPP components is provided in accordance with Part III.B.1a-1 of General Permit GP-0-20-001:
  - Background information: The proposed project includes a building addition which consists of a new apparatus bay space, support spaces for equipment, storage and training as well as the addition of a new driveway, relocation of utilities and site amenities. The existing building will be repurposed to include office, meeting and display spaces.
  - Site map / construction drawing: These plans serve to satisfy this SWPPP requirement.
  - Description of the soils present at the site: Onsite soils located within the proposed limits of disturbance consist of Urban (and) Chariton complex (Urb), as identified on the Soil Conservation Service Web Soil Survey. These soil types belong to the Hydrologic Soil Group "D."
  - Construction phasing plan / sequence of operations: The Construction Sequence and phasing found on these plans provide the required phasing. A Construction Sequence and Erosion and Sediment Control Maintenance Schedule has been provided. The Sedimentation and Erosion Control Notes contained herein outline a general sequence of operations for the proposed project. In general all erosion and sediment control facilities shall be installed prior to commencement with land disturbing activities, and areas of disturbance shall be limited to the shortest period of time as practicable.
  - Description of erosion and sediment control practices: This plan, and details / notes shown herein serve to satisfy this SWPPP requirement.
  - Temporary and permanent soil stabilization plan: The Sedimentation and Erosion Control Notes and Details provided herein identify temporary and permanent stabilization measures to be employed with respect to specific elements of the project, and at the various stages of development.
  - Site map / construction drawing showing the specific locations, sizes, and lengths of each erosion and sediment control practice: This plan serves to satisfy this SWPPP requirement.
  - The dimensions, material specifications, installation details, and operation and maintenance requirements for all erosion and sediment control practices. The details, Erosion and Sediment Control Notes, and Erosion and Sediment Control Maintenance Schedule serve to satisfy this SWPPP requirement.
  - An inspection schedule: Inspections are to be performed daily by a NYSDEC Trained Contractor as cited in the Erosion and Sediment Control Notes.
  - A description of pollution prevention measures that will be used to control litter, construction chemicals and construction debris: In general, all construction litter debris shall be collected and removed from the site. The general contractor shall supply either waste barrels or dumpsters for proper waste disposal. Any construction chemicals utilized during construction shall either be removed from site daily by the contractor or stored in a structurally sound and weatherproof building. No hazardous waste shall be disposed of onsite, and shall ultimately be disposed of in accordance with all federal, state and local regulations. Material Safety Data Sheets (MSDS), material inventory, and emergency contact numbers shall be maintained by the general contractor for all construction chemicals utilized onsite. Finally, temporary sanitary facilities (portable toilets) shall be provided onsite during the entire length of construction, and inspected weekly for evidence of leaking holding tanks.
  - A description and location of any stormwater discharges associated with industrial activity other than construction at the site: There are no known industrial stormwater discharges present or proposed at the site.
  - Identification of any elements of the design that are not in conformance with the technical standard, "New York Standards and Specifications for Erosion and Sediment Control." All proposed elements of this SWPPP have been designed in accordance with the "New York Standards and Specifications for Erosion and Sediment Control."

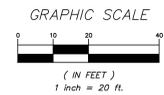

4	4-29-21	PLANNING BOARD SUBMISSION	MEU
3	10-8-20	PLANNING BOARD SUBMISSION	ERA
2	8-7-20	PLANNING BOARD SUBMISSION	KMG
1	7-17-20	PLANNING BOARD SUBMISSION	ERA
NO.	DATE	REVISION	BY

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PROJECT: **CARMEL FIRE DEPARTMENT**

94 GLENDALE AVENUE, CARMEL, PUTNAM COUNTY, NEW YORK


DRAWING: **EROSION AND SEDIMENT CONTROL PLAN**

PROJECT NUMBER: 19135.100 PROJECT MANAGER: J.M.W. DRAWING NO.: SHEET 4

DATE: 5-20-20 DRAWN BY: C.B.Z.


SCALE: 1" = 20' CHECKED BY: K.M.G.

3 Carmel Place  
Carmel, NY 10512  
(845) 225-8680  
(845) 225-9717 fax  
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**FIRE TRUCK VEHICLE MANEUVER**

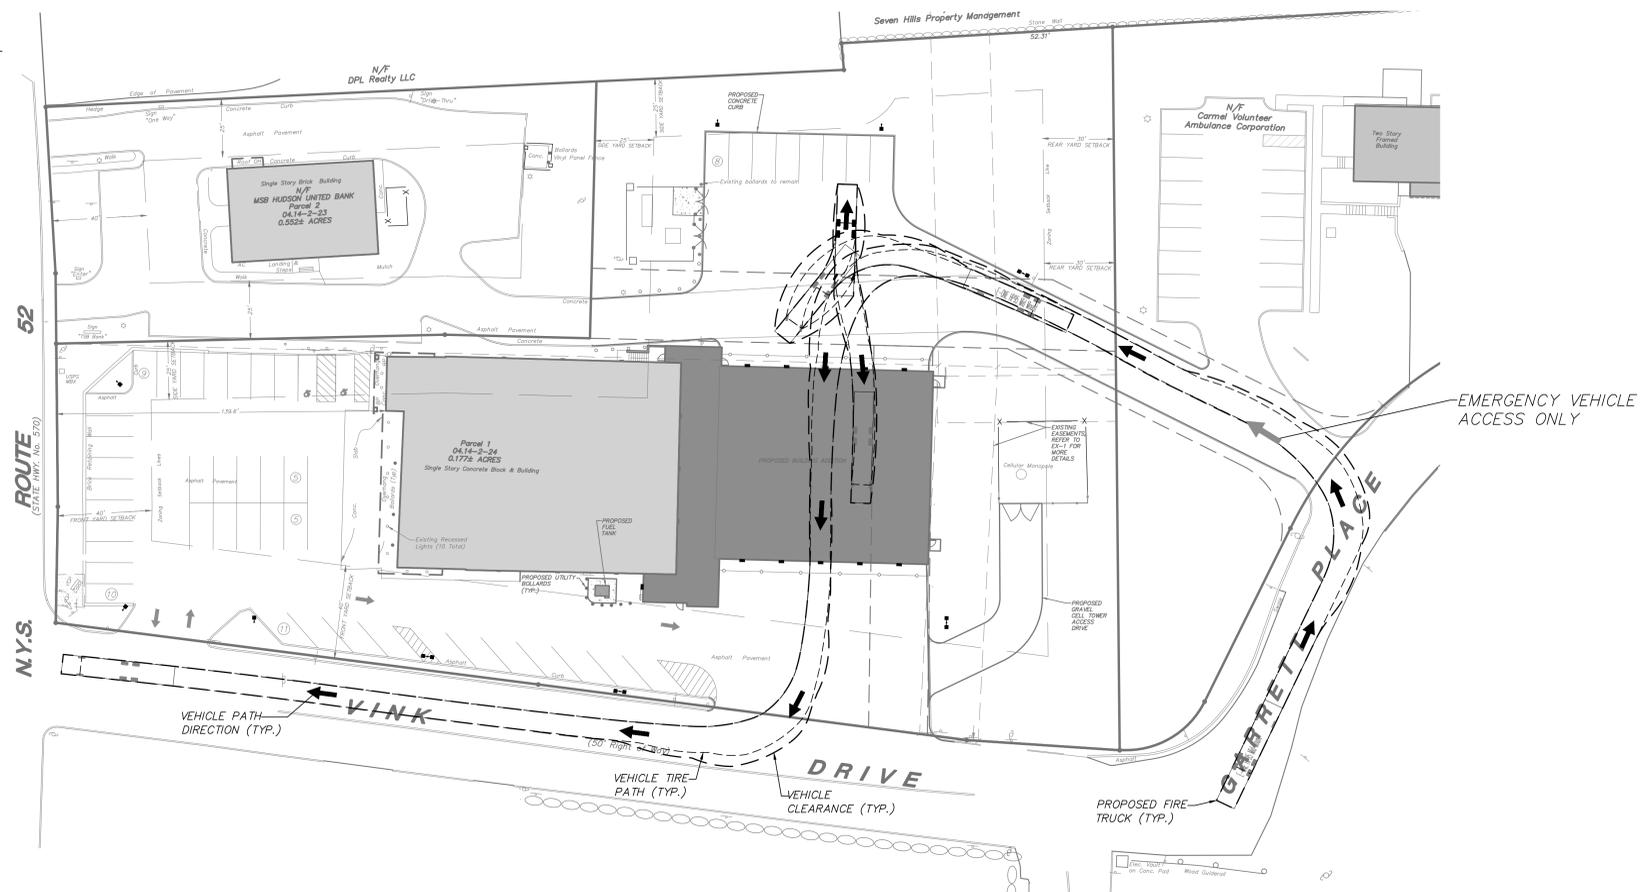SCALE: 1" = 30'  
 NOTE: The fire truck used for vehicle maneuvering is an "E-ONE HP95 Mid Mount". The overall length is 47'-9" and width is 8'-4". The dimensions show that a fire truck of this size, or similar, will be able to maneuver through the property.




**REFUSE TRUCK VEHICLE MANEUVER**

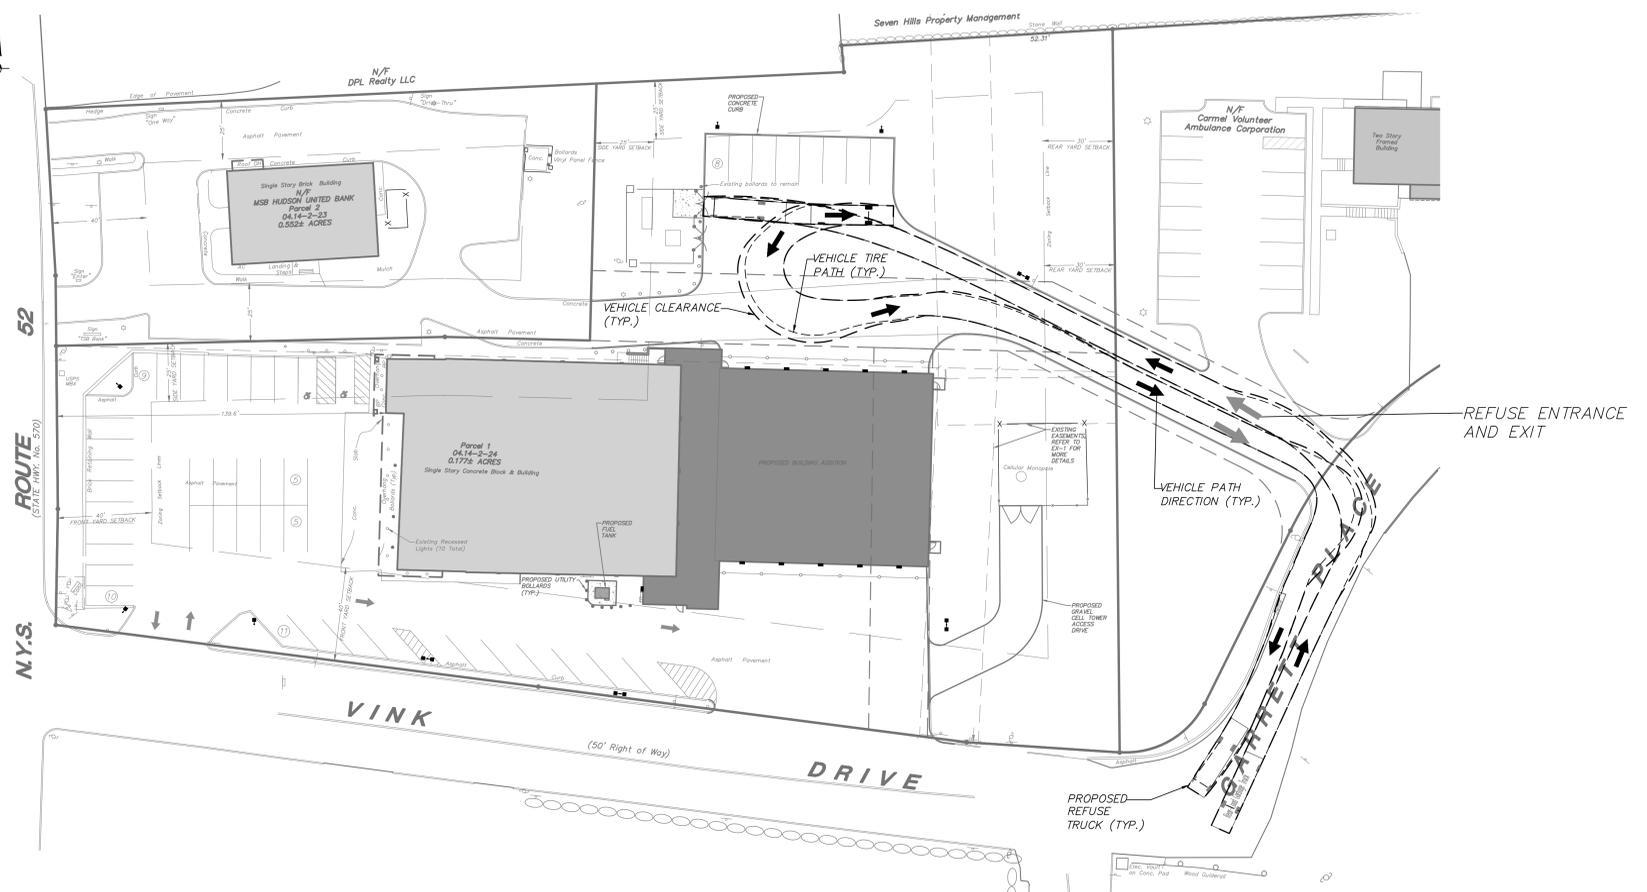SCALE: 1" = 30'  
 NOTE: The refuse truck used for vehicle maneuvering is a standard truck with an overall length of 35'-0" and width of 8'-4". These standard dimensions show that a garbage truck of this size, or similar, will be able to maneuver through the property.

LEGEND	
	EXISTING PROPERTY LINE
	EXISTING EASEMENT
	EXISTING STONE WALL
	EXISTING CHAIN LINK FENCE
	EXISTING STOCKADE FENCE
	EXISTING CONCRETE CURB
	EXISTING DROP IN CONCRETE CURB
	EXISTING SIGN
	EXISTING POST MOUNTED LIGHT
	EXISTING RECESSED LIGHT
	EXISTING UTILITY POLE
	PROPOSED # OF STALLS TO BE STRIPED
	PROPOSED CONCRETE CURB
	PROPOSED PAINTED HANDICAP PARKING SYMBOL
	PROPOSED STRIPED ISLAND
	PROPOSED SINGLE POLE SIGN
	PROPOSED POLE MOUNTED LIGHT
	PROPOSED BUILDING MOUNTED LIGHT

EMERGENCY VEHICLE ACCESS ONLY

REFUSE ENTRANCE AND EXIT

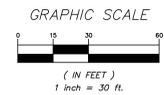

NO.	DATE	REVISION	BY
3	4-29-21	PLANNING BOARD SUBMISSION	MEU
2	10-8-20	PLANNING BOARD SUBMISSION	ERA
1	8-7-20	PLANNING BOARD SUBMISSION	KMG

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PROJECT: **CARMEL FIRE DEPARTMENT**  
 94 GLENEDA AVENUE, CARMEL, PUTNAM COUNTY, NEW YORK


DRAWING: **VEHICLE MANEUVERING PLAN**

PROJECT NUMBER: 19135.100 PROJECT MANAGER: J.M.W.  
 DATE: 7-17-20 DRAWN BY: J.F.R.  
 SCALE: 1" = 30' CHECKED BY: K.M.G.

DRAWING NO. **SP-4** SHEET 5 OF 10

ALTERATION OF THIS DOCUMENT, UNLESS UNDER THE DIRECTION OF A LICENSED PROFESSIONAL ENGINEER, IS A VIOLATION OF SECTION 2209 OF ARTICLE 145 OF THE EDUCATION LAW.

LEGEND	
	EXISTING PROPERTY LINE
	EXISTING EASEMENT
	EXISTING STONE WALL
	EXISTING CHAIN LINK FENCE
	EXISTING STOCKADE FENCE
	EXISTING CONCRETE CURB
	EXISTING DROP IN CONCRETE CURB
	EXISTING SIGN
	EXISTING POST MOUNTED LIGHT
	EXISTING RECESSED LIGHT
	EXISTING UTILITY POLE
	PROPOSED # OF STALLS TO BE STRIPED
	PROPOSED CONCRETE CURB
	PROPOSED PAINTED HANDICAP PARKING SYMBOL
	PROPOSED STRIPED ISLAND
	PROPOSED SINGLE POLE SIGN
	PROPOSED POLE MOUNTED LIGHT
	PROPOSED BUILDING MOUNTED LIGHT

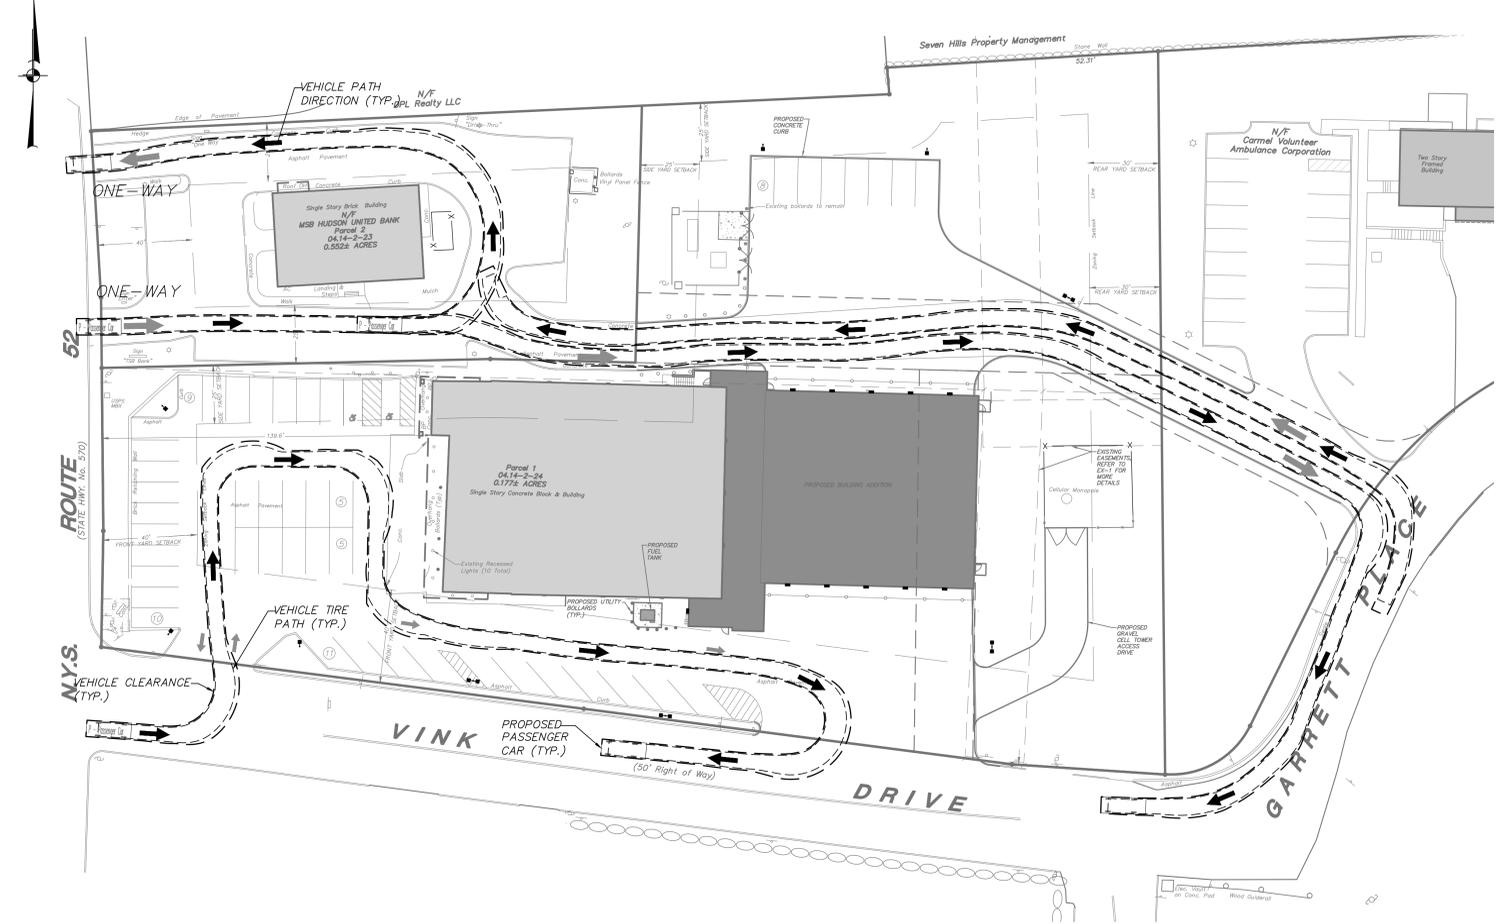


**PASSENGER CAR VEHICLE MANEUVER**  
 SCALE: 1" = 30'  
 NOTE: The passenger car used for vehicle maneuvering is a standard vehicle with an overall length of 19'-0" and width of 7'-0". These standard dimensions show that a passenger car of this size, or similar, will be able to maneuver through the property.


NO.	DATE	REVISION	BY
3	4-29-21	PLANNING BOARD SUBMISSION	MEU
2	10-8-20	PLANNING BOARD SUBMISSION	ERA
1	8-7-20	PLANNING BOARD SUBMISSION	KMG

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PROJECT: **CARMEL FIRE DEPARTMENT**  
 94 GLENEDA AVENUE, CARMEL, PUTNAM COUNTY, NEW YORK  
 DRAWING: **VEHICLE MANEUVERING PLAN**

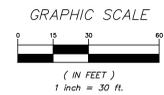

PROJECT NUMBER	19135.100	PROJECT MANAGER	J.M.W.	DRAWING NO.	SHEET
DATE	7-17-20	DRAWN BY	J.F.R.	SP-5	6
SCALE	1" = 30'	CHECKED BY	K.M.G.		10

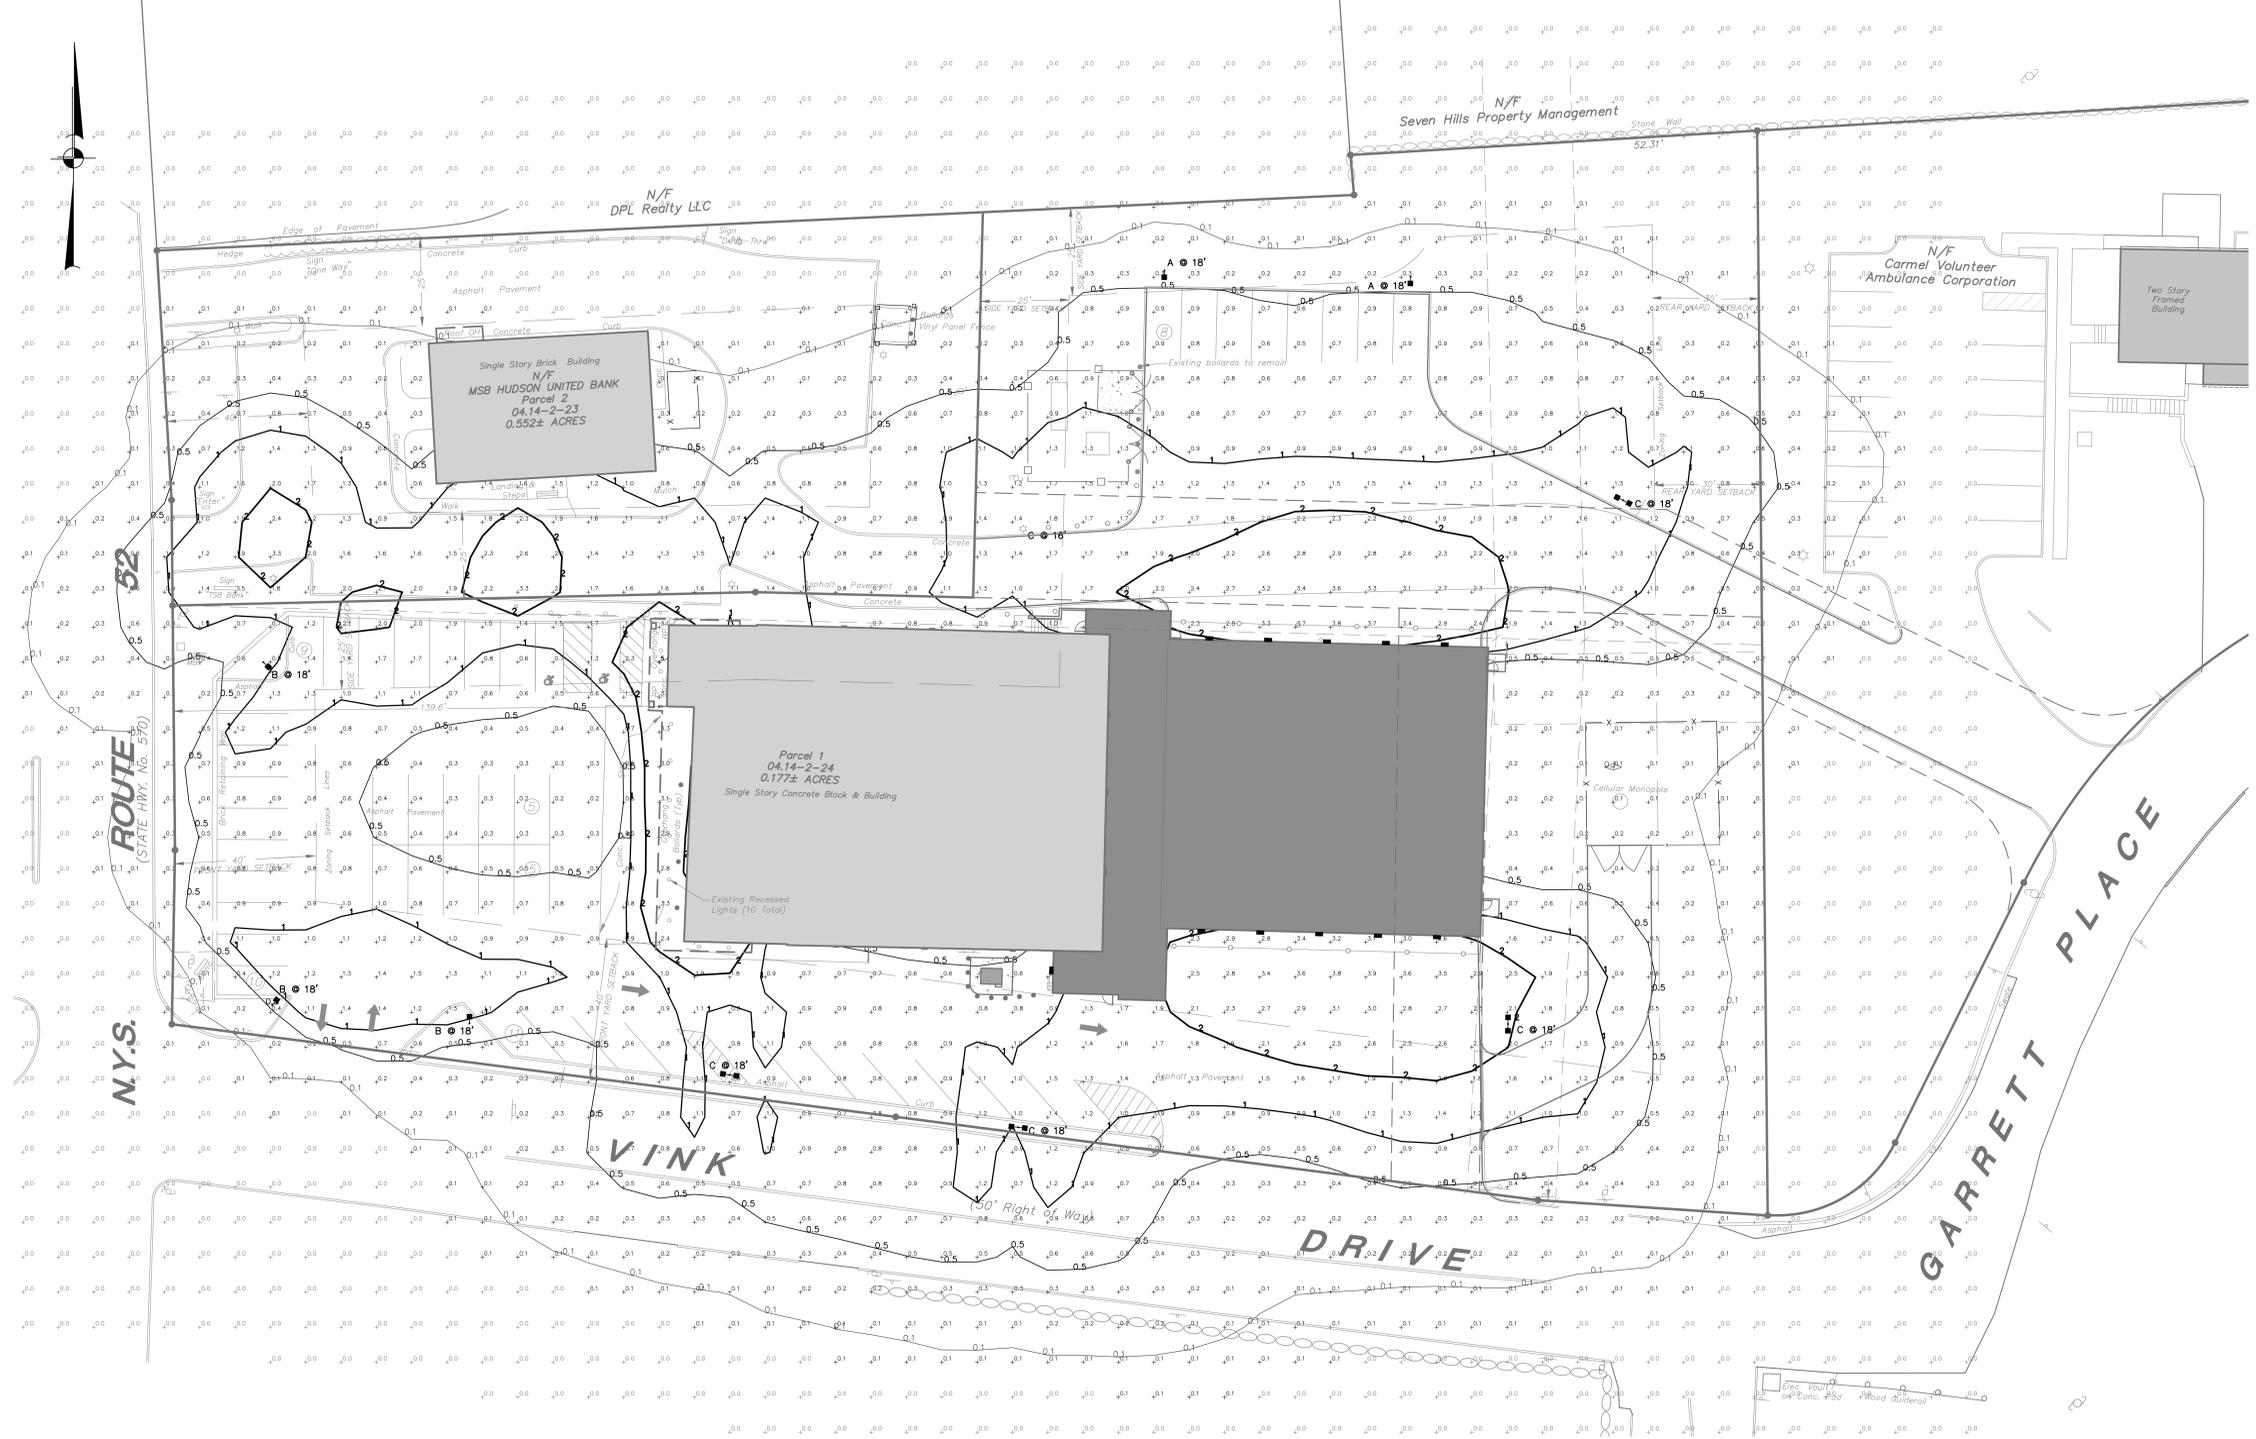

**LEGEND**

	EXISTING PROPERTY LINE
	EXISTING EASEMENT
	EXISTING STONE WALL
	EXISTING CHAIN LINK FENCE
	EXISTING STOCKADE FENCE
	EXISTING CONCRETE CURB
	EXISTING DROP IN CONCRETE CURB
	EXISTING SIGN
	EXISTING HEDGE ROW
	EXISTING TREELINE
	EXISTING POST MOUNTED LIGHT
	EXISTING RECESSED LIGHT
	EXISTING UTILITY POLE
	PROPOSED # OF STALLS TO BE STRIPED
	PROPOSED CONCRETE CURB
	PROPOSED PAINTED HANDICAP PARKING SYMBOL
	PROPOSED STRIPED ISLAND
	PROPOSED SINGLE POLE SIGN
	PROPOSED POLE MOUNTED LIGHT
	PROPOSED BUILDING MOUNTED LIGHT

- LIGHTING NOTES:**
- All lighting shall be as noted on the plan or approved equal.
  - Style and finish of all luminaires to be selected by owner.
  - Calculation values shown in this plan are taken on a horizontal plane at ground level using a 0.90 light loss factor for LEDs. Topographical information and landscaping have not been accounted for in these calculations.
  - Photometric modeling based on similar or specified fixtures.
  - Lighting plan assumes that certain light fixtures will utilize existing foundations. Contractor verify prior to ordering fixtures and shall notify Project Landscape Architect if built pattern differs.
  - Light levels generated from lighting on adjacent properties are approximate and shown for informational purposes only.

**LUMINAIRE SCHEDULE**

Symbol	Qty	Catalog Number	Description	Lamp	Mounting Height
A	2	UCM2-ANC-36L-260-3K7-4W-10	ARCHITECTURAL AREA LIGHTING, UNIVERSE COLLECTION, MEDIUM 2.0, HOUSE-SIDE SHIELD	LED	18' - 0"
B	8	UCM2-ANC-36L-260-3K7-4W	ARCHITECTURAL AREA LIGHTING, UNIVERSE COLLECTION, MEDIUM 2.0	LED	AS NOTED
D	10	UCM2-ANC-36L-260-3K7-4W	ARCHITECTURAL AREA LIGHTING, UNIVERSE COLLECTION, MEDIUM 2.0	LED	18' - 4 1/2"
	10	N/A	EXISTING RECESSED BUILDING MOUNTED LIGHTING, MODELED FOR REFERENCE ONLY.	LED	N/A
	3	N/A	EXISTING FIXTURES LOCATED ON NEIGHBORING PARCEL, MODELED FOR REFERENCE ONLY.	LED	N/A

**STATISTICS**

DESCRIPTION	SYMBOL	AVG	MAX	MIN	AVG/MAX	AVG/MIN
Project Area		0.5 fc	5.4 fc	0.0 fc	N/A	N/A

**LIGHT CONTOUR LEGEND**

0.1	0.10 Foot Candles
0.5	0.50 Foot Candles
1	1.00 Foot Candles
2	2.00 Foot Candles

\* Photometric calculations shown on plan are in foot candles.


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- Reliable, uniform, glare free illumination
- Types II, III, IV, V and custom distributions
- 3000K, 4000K, 5000K CCT
- 0-10V dimming ready
- Integral surge suppression
- 15 standard powder coat finishes
- Upgrade Kits

**CONTROL TECHNOLOGY**

wiSCAPE HUBBELL LIGHTING



3	4-29-21	PLANNING BOARD SUBMISSION	MEU
2	10-8-20	PLANNING BOARD SUBMISSION	ERA
1	8-7-20	PLANNING BOARD SUBMISSION	KMG
NO.	DATE	REVISION	BY
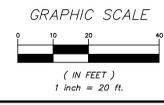
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PROJECT: **CARMEL FIRE DEPARTMENT**


94 GLENEDA AVENUE, CARMEL, PUTNAM COUNTY, NEW YORK

DRAWING: **LIGHTING PLAN**


PROJECT NUMBER: 19135.100 PROJECT MANAGER: J.M.W.  
DATE: 7-17-20 DRAWN BY: J.F.R.  
SCALE: 1" = 20' CHECKED BY: K.M.G.

DRAWING NO. SHEET: **LP-1** 7/10


ALTERATION OF THIS DOCUMENT, UNLESS UNDER THE DIRECTION OF A LICENSED PROFESSIONAL ENGINEER, IS A VIOLATION OF SECTION 2209 OF ARTICLE 145 OF THE EDUCATION LAW.

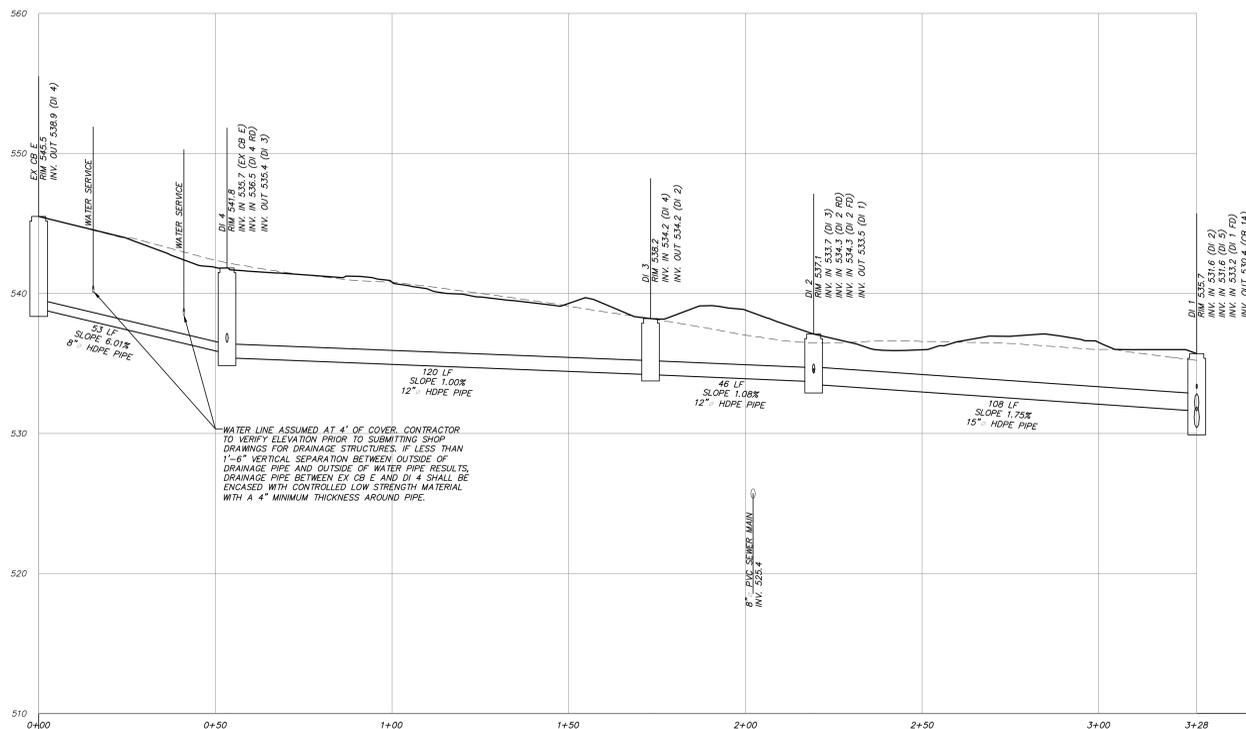



**EX CB TO DI 1**  
SCALE: HORIZ. 1" = 20'  
VER. 1" = 5'

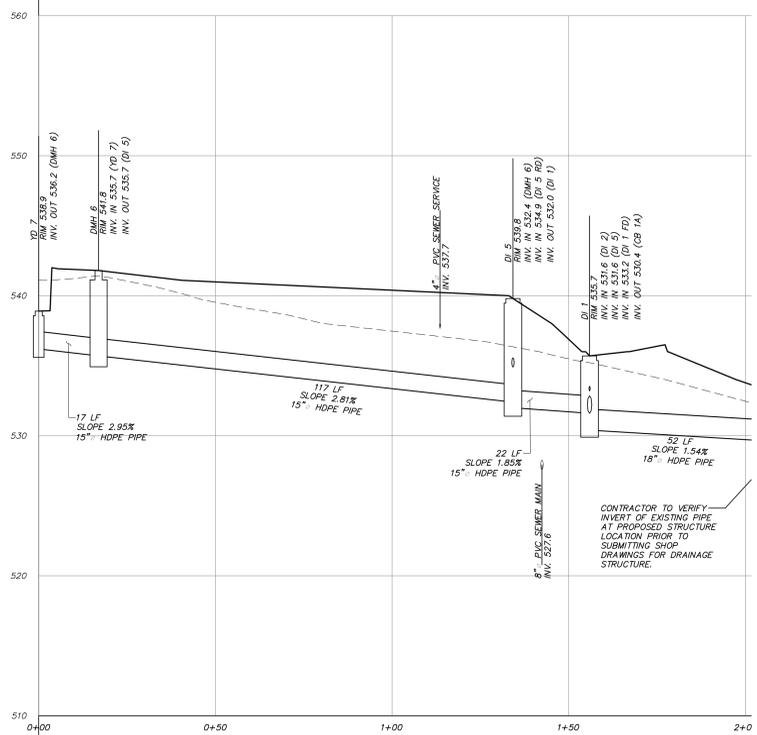

**YD 7 TO DI 1**  
SCALE: HORIZ. 1" = 20'  
VER. 1" = 5'

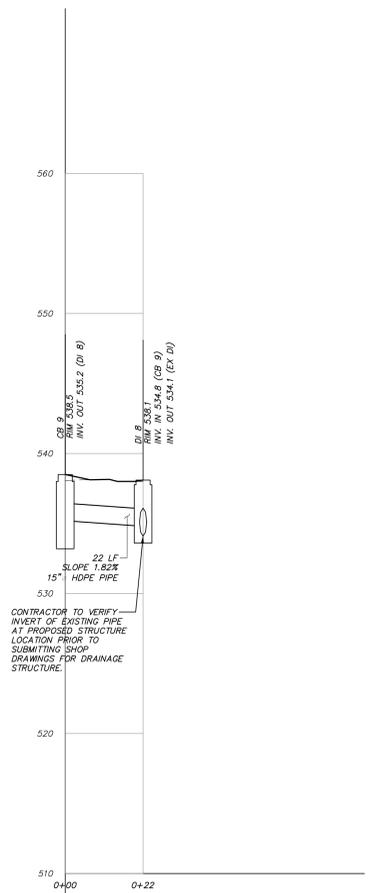

**CR 9 TO DI 8**  
SCALE: HORIZ. 1" = 20'  
VER. 1" = 5'

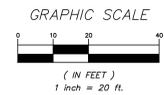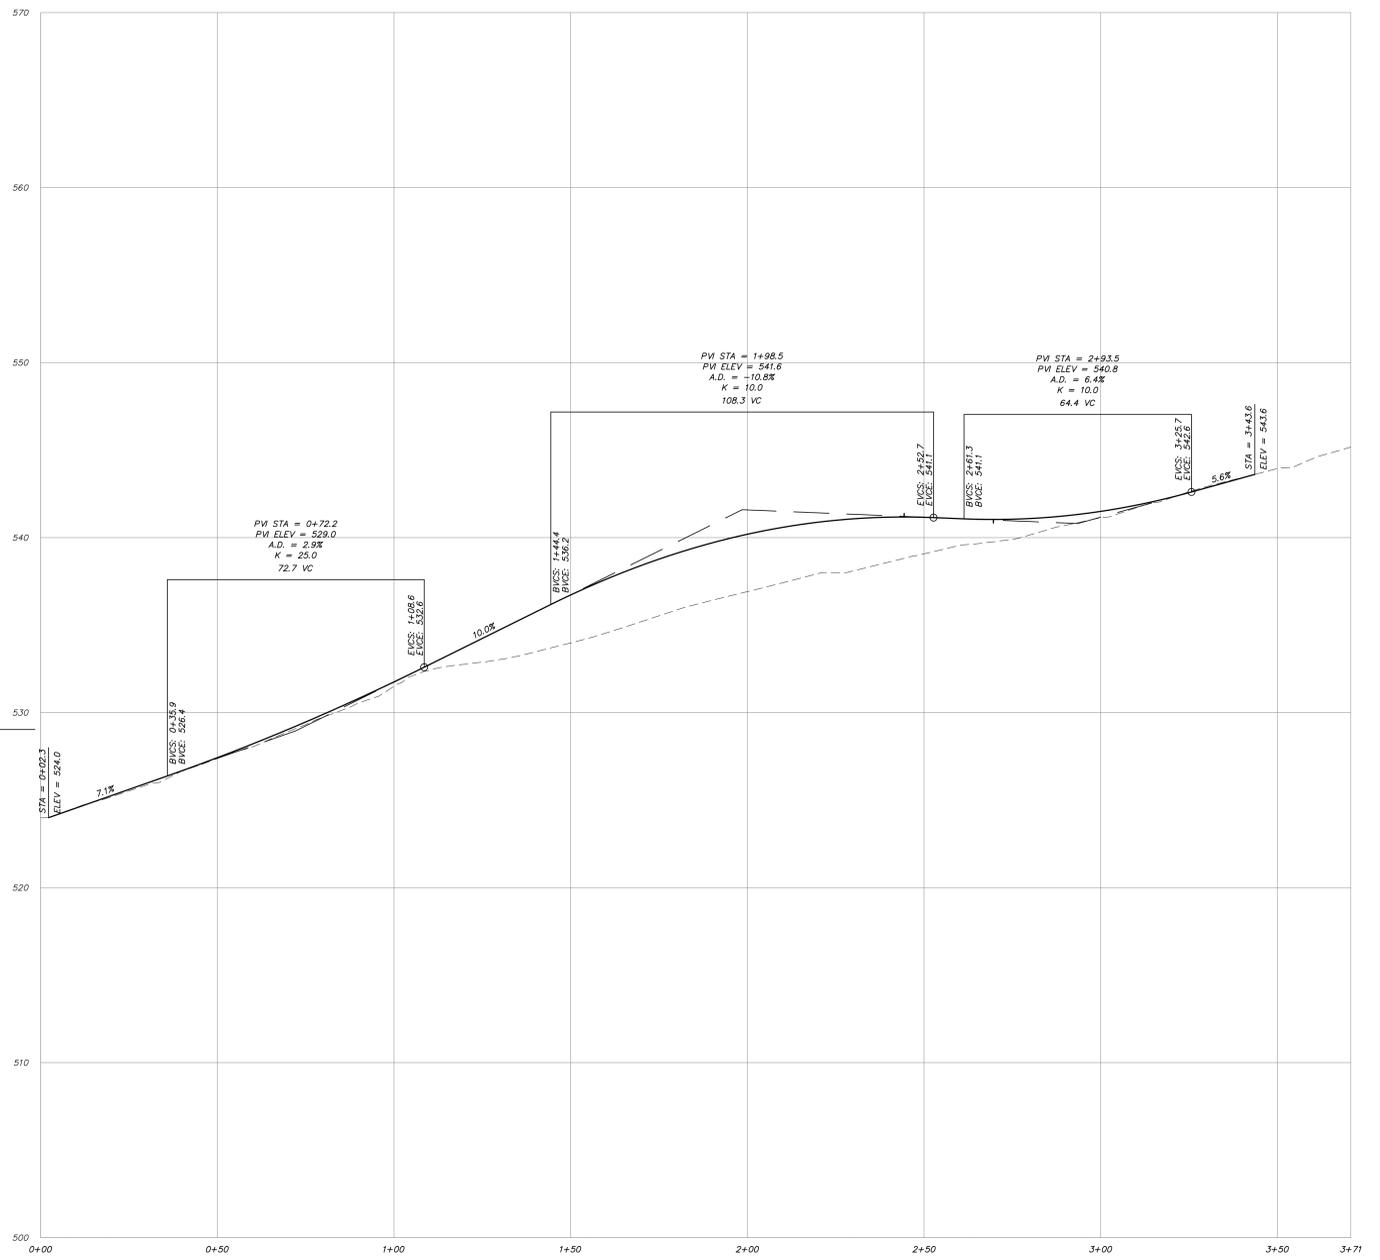

3	4-29-21	PLANNING BOARD SUBMISSION	MEU
2	10-8-20	PLANNING BOARD SUBMISSION	ERA
1	8-7-20	PLANNING BOARD SUBMISSION	KMG
NO.	DATE	REVISION	BY

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PROJECT: **CARMEL FIRE DEPARTMENT**  
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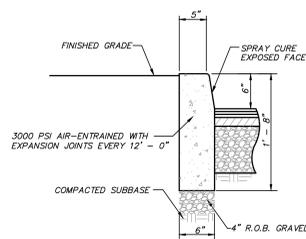
DRAWING: **PROFILES**

PROJECT NUMBER: 19135.100  
DATE: 7-17-20  
SCALE: AS SHOWN


PROJECT MANAGER: J.M.W.  
DRAWN BY: C.B.Z.  
CHECKED BY: K.M.G.

DRAWING NO. SHEET: **PR-1** 8/10

ALTERATION OF THIS DOCUMENT, UNLESS UNDER THE DIRECTION OF A LICENSED PROFESSIONAL ENGINEER, IS A VIOLATION OF SECTION 2209 OF ARTICLE 145 OF THE EDUCATION LAW.




**CONCRETE CURB DETAIL**  
(N.T.S.)

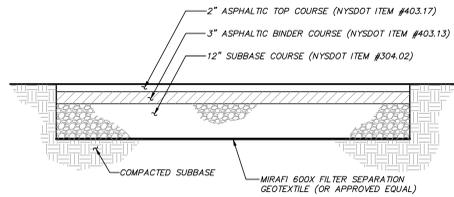


**ASPHALT PAVEMENT DETAIL**  
(N.T.S.)

NOTE: DRIVEWAYS SHALL MEET CONSTRUCTION REQUIREMENTS AS OUTLINED IN THE TOWN OF CARMEL CODE §128 STREETS AND SIDEWALKS.

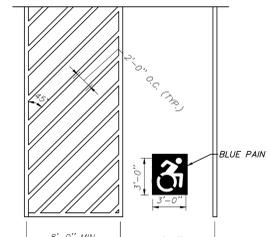


**PAINTED NYS ACCESSIBLE PARKING DETAIL**  
(N.T.S.)

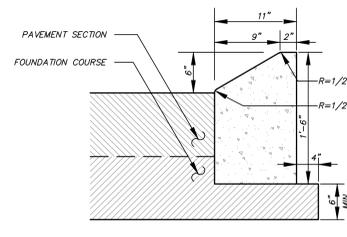


**MOUNTABLE CONCRETE CURB DETAIL**  
(N.T.S.)

NOTE: TRANSVERSE JOINTS 1/2" WIDE SHALL BE INSTALLED IN THE CURB 10'-0" APART AND SHALL BE FILLED WITH CELLULAR COMPRESSION MATERIALS AS SPECIFIED, RECESSED 1/4" IN FROM FRONT FACE AND TOP OF CURB.

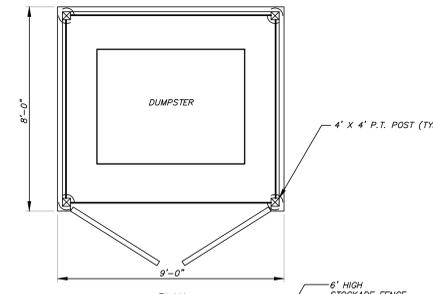


**DUMPSTER ENCLOSURE DETAIL**  
(N.T.S.)

NOTE: CHECK WITH REFUSE HAULER PRIOR TO INSTALLATION OF REFUSE ENCLOSURE FOR DIMENSIONS.

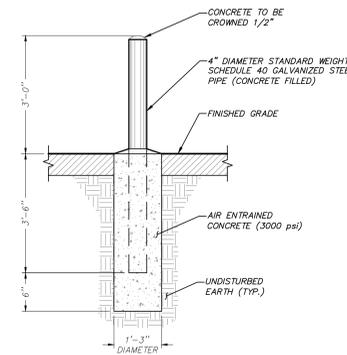


**STEEL BOLLARD DETAIL**  
(N.T.S.)

NOTES:  
1. WHEN BOLLARDS ARE TO BE USED FOR PROTECTION OF COMBUSTIBLE OBJECTS, POSTS SHALL BE OFFSET A MINIMUM OF THREE (3) FEET FROM THE OBJECT BEING PROTECTED.  
2. BOLLARDS (WHEN MORE THAN ONE IS REQUIRED) SHALL BE SPACED NOT MORE THAN FOUR (4) FEET ON CENTER WHEN PROTECTING COMBUSTIBLE OBJECTS.

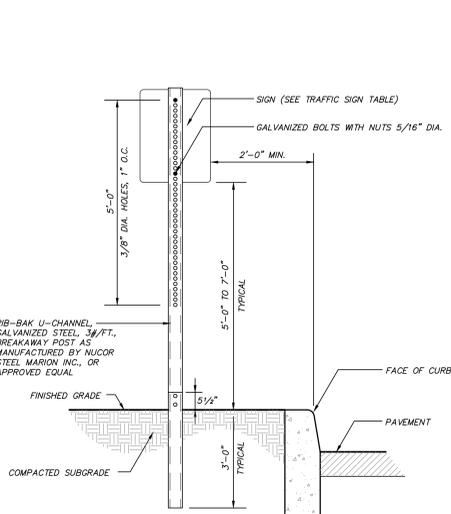


**TRAFFIC SIGN DETAIL**  
(N.T.S.)

NOTE: FOR HANDICAP PARKING SIGNAGE, SIGNS SHALL BE INSTALLED AT A CLEAR HEIGHT OF BETWEEN 5'-0" AND 7'-0" ABOVE GRADE OF PARKING SPACE AND SUCH THAT SIGNS SHALL NOT BE OBSCURED BY A VEHICLE PARKED IN THE SPACE.

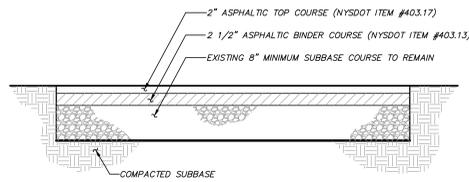


**REPLACEMENT ASPHALT PAVEMENT DETAIL**  
(N.T.S.)

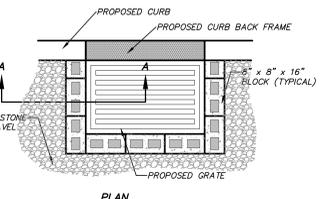


**TREE PROTECTION DETAIL**  
(N.T.S.)

NOTES:  
1. INSTALL BARRIER AS SHOWN TO PREVENT COMPACTION OF SOIL AROUND ROOTS BY CONSTRUCTION EQUIPMENT.  
2. OPTIONAL: 2" X 6" WOOD FRAMING BUILT AS SQUARE AROUND TREE, AS ALTERNATIVE.

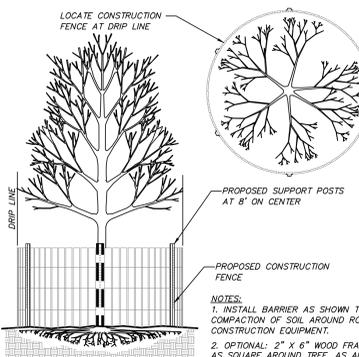


**STOCKADE FENCE DETAIL**  
(N.T.S.)

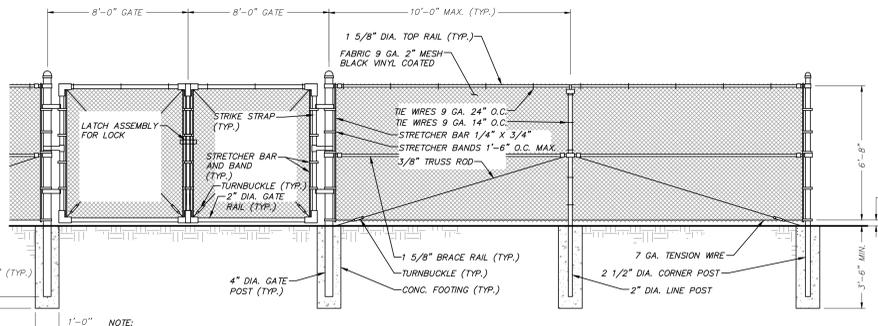


**CHAIN LINK FENCE DETAIL**  
(N.T.S.)

NOTE: ALL POSTS, RAILS, AND APPURTENANCES SHALL BE BLACK VINYL COATED.

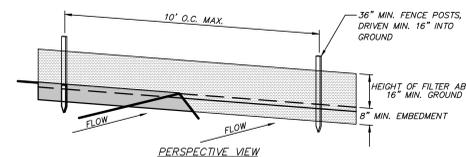


**SILT FENCE DETAIL**  
(N.T.S.)

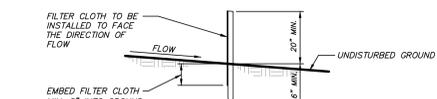

**CONSTRUCTION NOTES FOR FABRICATED SILT FENCE**


1. FILTER CLOTH TO BE FASTENED SECURELY TO POSTS AT TOP AND MID SECTION.
2. WHEN TWO SECTIONS OF FILTER CLOTH ADJOIN EACH OTHER THEY SHALL BE OVERLAPPED BY SIX INCHES AND FOLDED.
3. MAINTENANCE SHALL BE PERFORMED AS NEEDED AND MATERIAL REMOVED WHEN 'BULGES' DEVELOP IN THE SILT FENCE.

POSTS: STEEL EITHER T OR U TYPE OR 2" HARDWOOD  
FILTER CLOTH: FILTER X, MIRAFIX 600X, STABILUNKA T140N, OR APPROVED EQUAL  
PREFABRICATED UNIT: GEFAB, ENVIRONMENTAL, OR APPROVED EQUAL

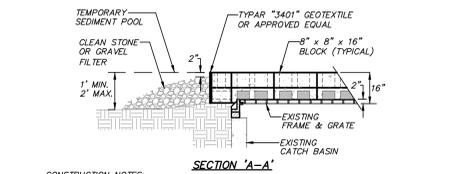


**CATCH BASIN IN EXISTING PAVEMENT STONE AND BLOCK DROP INLET PROTECTION DETAIL**  
(N.T.S.)

CONSTRUCTION NOTES:  
1. LAY ONE LAYER OF BLOCKS ON EACH SIDE OF THE STRUCTURE ON THEIR SIDES FOR DOWELING. EDGES OF BLOCK SHALL BE 2 INCHES MINIMUM BELOW THE GRATE. BLOCKS SHALL BE PLACED AGAINST THE INLET FOR SUPPORT. PLACE A SECOND LAYER OF BLOCKS ON TOP OF THE FIRST LAYER WITH HOLE FACE UP.  
2. GEOTEXTILE SHALL BE PLACED OVER BLOCK OPENINGS TO SUPPORT STONE.  
3. USE CLEAN STONE OR GRAVEL 1/2 TO 3/4 INCH IN DIAMETER PLACED ON A 3% SLOPE OR FLATTER, TO WITHIN 2 INCHES OF THE TOP OF THE BLOCKS.

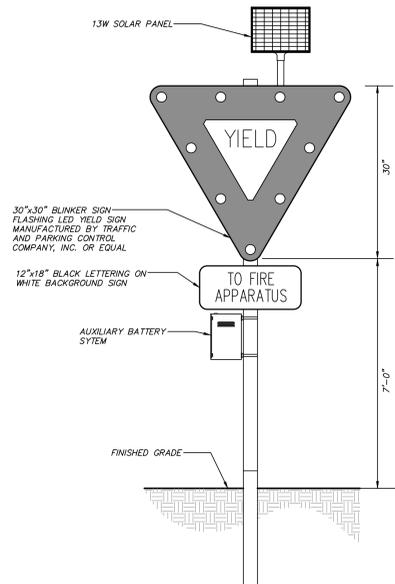


**FLASHING YIELD SIGN DETAIL**  
(N.T.S.)

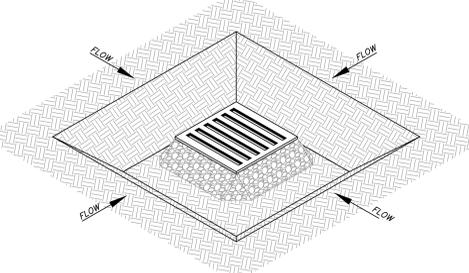


**EXCAVATED DROP INLET PROTECTION DETAIL**  
(N.T.S.)

1. CLEAR THE AREA OF ALL DEBRIS THAT WILL HINDER EXCAVATION
2. GRADE APPROACH TO THE INLET UNIFORMLY AROUND THE BASIN
3. WEEP HOLES SHALL BE PROTECTED BY GRAVEL
4. UPON STABILIZATION OF CONTRIBUTING DRAINAGE AREA, SEAL WEEP HOLES, FILL EXCAVATION WITH STABLE SOIL TO FINAL GRADE, COMPACT IT PROPERLY, AND STABILIZE WITH PERMANENT SEEDING
5. MAXIMUM DRAINAGE AREA = 1 ACRE

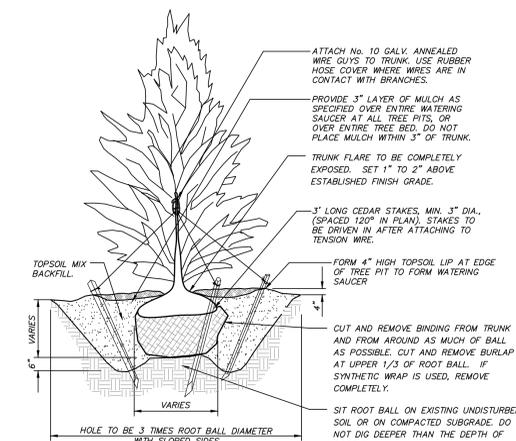

**EVERGREEN TREE PLANTING DETAIL**  
(N.T.S.)

NOTE: PROVIDE STAKING AND GUYING FOR TREES PLANTED ON SLOPES GREATER THAN 3% IN EXPOSED, WINDY AREAS AND AS SPECIFIED BY LANDSCAPE ARCHITECT. GUY WIRES AND STAKES SHALL BE REMOVED WITHIN TWELVE MONTHS OF PLANTING.

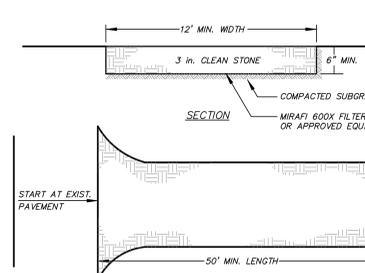

**STABILIZED CONSTRUCTION ENTRANCE DETAIL**  
(N.T.S.)

INSTALLATION NOTES:  
1. STONE SIZE - USE 3" STONE  
2. LENGTH - AS REQUIRED, BUT NOT LESS THAN 50 FEET (EXCEPT ON A SINGLE RESIDENCE LOT WHERE A 30 FOOT MINIMUM LENGTH WOULD APPLY.)  
3. THICKNESS - NOT LESS THAN SIX (6) INCHES  
4. WIDTH - 12 FOOT MINIMUM, BUT NOT LESS THAN THE FULL WIDTH AT POINTS WHERE INGRESS OR EGRESS OCCUR.  
5. FILTER CLOTH - WILL BE PLACED OVER THE ENTIRE AREA PRIOR TO PLACING OF STONE. FILTER CLOTH WILL NOT BE REQUIRED ON A SINGLE FAMILY RESIDENCE LOT.  
6. SURFACE WATER - ALL SURFACE WATER FLOWING OR DIVERTED TOWARD CONSTRUCTION ENTRANCES SHALL BE PIPED ACROSS THE ENTRANCE. IF PIPING IS IMPRACTICAL, A MOUNTABLE BERM WITH 5:1 SLOPES WILL BE PERMITTED.  
7. MAINTENANCE - THE ENTRANCE SHALL BE MAINTAINED IN A CONDITION WHICH WILL PREVENT TRACKING OR FLOWING OF SEDIMENT ONTO PUBLIC RIGHT OF WAY THIS MAY REQUIRE PERIODIC TOP DRESSING WITH ADDITIONAL STONE AS CONDITIONS DEMAND AND REPAIR AND/OR CLEANOUT OF ANY MEASURES USED TO TRAP SEDIMENT. ALL SEDIMENT SPILLED, DROPPED, WASHED OR TRACKED ONTO PUBLIC RIGHT OF WAY MUST BE REMOVED IMMEDIATELY.  
8. WASHING - WHEELS SHALL BE CLEANED TO REMOVE SEDIMENT PRIOR TO ENTRANCE ONTO PUBLIC RIGHT OF WAY WHEN WASHING IS REQUIRED. IT SHALL BE DONE ON AN AREA STABILIZED WITH STONE AND WHICH DRAINS INTO AN APPROVED SEDIMENT TRAPPING DEVICE.  
9. PERIODIC INSPECTION AND NEEDED MAINTENANCE SHALL BE PROVIDED AFTER EACH RAIN.

1. AREA CHOSEN FOR STOCKPILE LOCATION SHALL BE DRY AND STABLE.
2. MAXIMUM SLOPE OF STOCKPILE SHALL BE 2:1.
3. UPON COMPLETION OF SOIL STOCKPILING, EACH PILE SHALL BE IMMEDIATELY SEEZED WITH 10% PERENNIAL TALL FESCUE.
4. ALL STOCKPILES SHALL BE PROTECTED WITH SILT FENCING INSTALLED ON THE DOWNGRADIENT SIDE.

**TEMPORARY SOIL STOCKPILE DETAIL**  
(N.T.S.)

NO.	DATE	REVISION	BY
4	4-29-21	PLANNING BOARD SUBMISSION	MEU
3	10-8-20	PLANNING BOARD SUBMISSION	ERA
2	8-7-20	PLANNING BOARD SUBMISSION	KMG
1	7-17-20	PLANNING BOARD SUBMISSION	ERA

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(845) 225-9680  
(845) 225-9717 fax  
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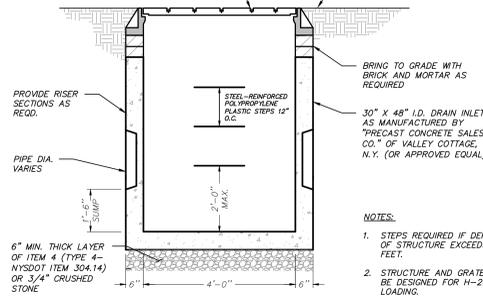
PROJECT: **CARMEL FIRE DEPARTMENT**  
94 GLENEDA AVENUE, CARMEL, PUTNAM COUNTY, NEW YORK  
DRAWING: **DETAILS**

PROJECT NUMBER	DATE	SCALE	PROJECT MANAGER	DRAWN BY	CHECKED BY	DRAWING NO.	SHEET
19135.100	5-20-20	AS NOTED	J.M.W.	J.F.R.	K.M.G.	D-1	9

**SEWER SERVICE NOTES**


- All sewer services shown on these plans shall be polyvinyl chloride (PVC) SDR 35 with factory installed push on gaskets.
- Sanitary Sewers shall be laid at least 10 feet horizontally from any existing or proposed water main. The distance shall be measured edge to edge. In cases where it is not practical to maintain a 10 foot horizontal separation, the Design Engineer and the Town of Carmel may allow deviation with prior approval on a case-by-case basis, if supported by data from the Design Engineer prior to sewer line installation. The horizontal separation also applies to service connections.
- Sewers crossing water mains shall be laid to provide a minimum vertical separation of 18 inches between the outside of the sewer main and the water main. The crossing shall be arranged so that the sewer joints will be equidistant and as far as possible from the water main joints. Where a water main crosses under a sewer, adequate structural support shall be provided for the sewer to maintain line and grade. In cases where it is not practical to maintain a 18" vertical separation, the Design Engineer and the Town of Carmel may allow deviation with prior approval on a case-by-case basis, if supported by data from the Design Engineer prior to the sewer line installation. The vertical separation also applies to service connections.

HEAVY DUTY CAST IRON FRAME & GRATE MODEL 3408 (BIKE SAFE) AS MANUFACTURED BY CAMPBELL FOUNDRY (OR APPROVED EQUAL). PROVIDE ADA COMPLIANT GRATE WHERE LOCATED IN PEDESTRIAN AREAS/ADA ACCESSIBLE ROUTES




**30" X 48" DRAIN INLET DETAIL**  
(N.T.S.)


- NOTES:
- STEPS REQUIRED IF DEPTH OF STRUCTURE EXCEEDS 4 FEET.
  - STRUCTURE AND GRATE TO BE DESIGNED FOR H-20 LOADING.

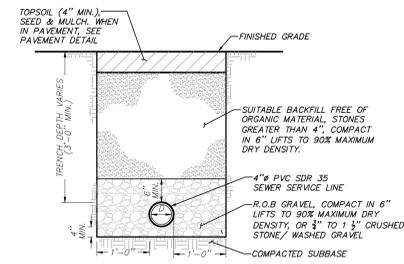


**SEWER SERVICE LINE TRENCH DETAIL**  
(N.T.S.)

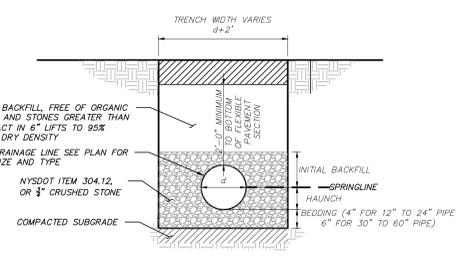

**DRAINAGE LINE TRENCH DETAIL**  
(N.T.S.)

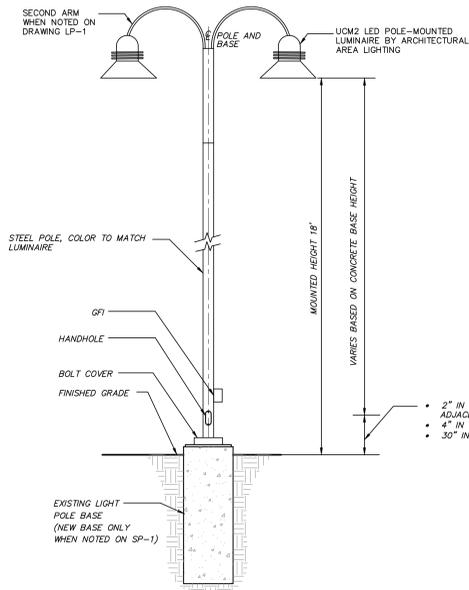


**POLE-MOUNTED AREA LIGHT DETAIL**  
(N.T.S.)

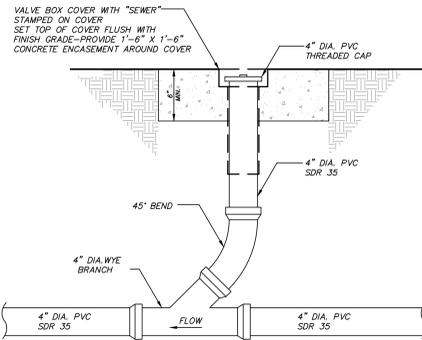


**SEWER LINE CLEANOUT DETAIL**  
(N.T.S.)


- 2" IN LAWN AREAS ADJACENT TO BUILDINGS
- 4" IN TREE LAWNS
- 30" IN PARKING AREAS

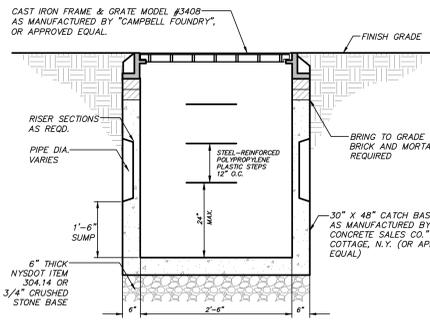



**30" X 48" CATCH BASIN DETAIL**  
(N.T.S.)

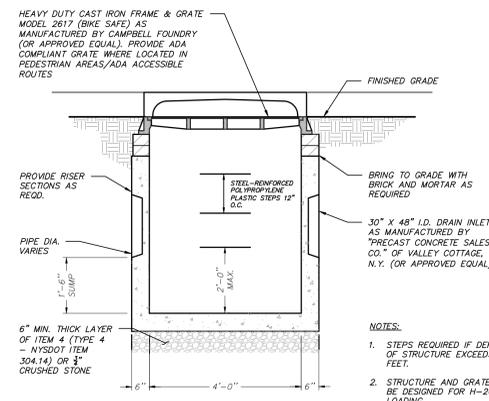


**30" X 48" CATCH BASIN DETAIL**  
(N.T.S.)

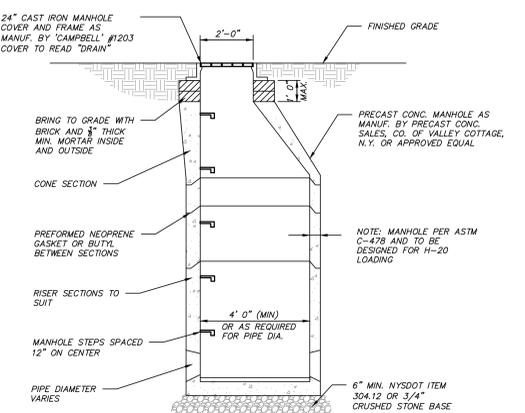

**DRAINAGE MANHOLE (DMH) DETAIL**  
(N.T.S.)

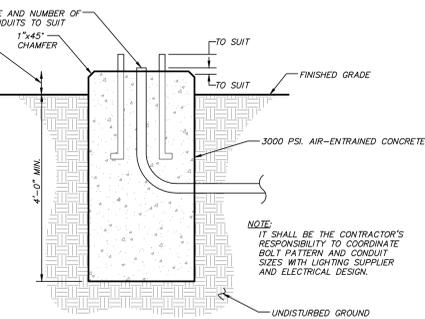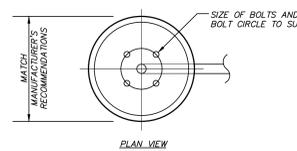


**LIGHT POLE BASE DETAIL**  
(N.T.S.)

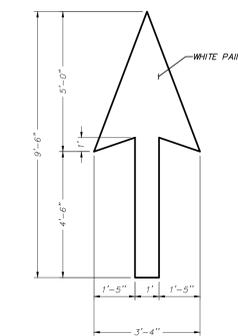


**DIRECTIONAL ARROWS DETAIL**  
(N.T.S.)

**SEWER SERVICE CONNECTION DETAIL**  
(N.T.S.)

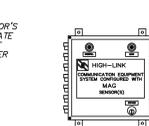


**COMMUNICATION BOX DETAIL**

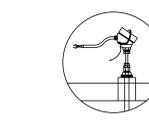


**HIGH-LINK FUEL SHIELD DETAIL**

**FUEL TANK INSTALLATION REQUIREMENTS:**


- FILLRITE FUEL DISPENSER PUMP AND METER (MP FR701V) OR EQUIVALENT METER TO BE PLUMED INLINE HORIZONTALLY WITH PUMP.
- REMOVE FILL CONTAINMENT CHAMBER
- TWO 4" EMERGENCY VENTS
- 46" SCULLY GOLDEN GALLON GAUGE (MFG 03158)
- LEAK DETECTION GAUGE
- VENT PIPE WITH CAP
- OVERFILL PROTECTION VALVE 90855 (AUTOMATIC SHUT OFF) ON FILL PORT
- LABEL TANK AS PER NYSDEC PES
- ALL TANK APPURTENANCES TO BE LOCATED PER DIRECTION OF CARMEL FIRE DEPARTMENT
- TANK SHOULD BE GROUNDED AS PER FEDERAL AND/OR STATE REGULATIONS
- HIGH-LINK FUEL SHIELD-MINI FUEL MANAGEMENT SYSTEM.

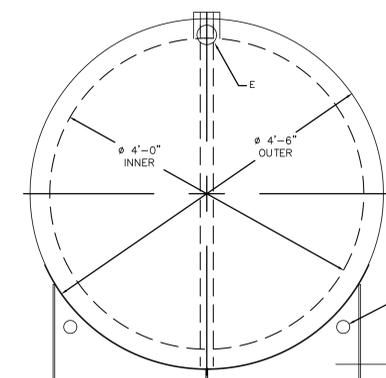

**END VIEW**

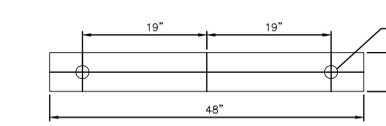

**SADDLE VIEW**

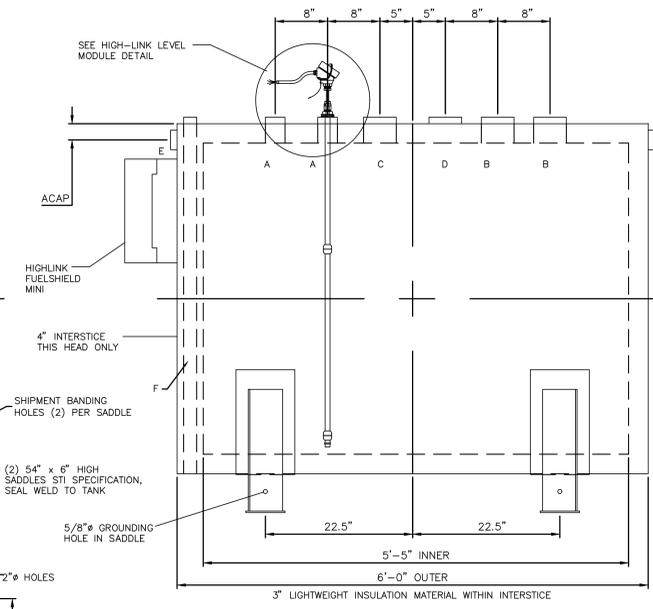

**SIDE VIEW**


**500 GAL 48" DIAMETER FIREGUARD TANK**  
(N.T.S.)

**DESIGN DATA**

CAPACITY :	500 GALLONS
TYPE:	FIREGUARD® CYLINDRICAL
FIREGUARD® IS A TRADEMARK OF THE STEEL TANK INSTITUTE	
NO. REQ.	---
OPERATING PRESSURE -	ATMOSPHERIC
SPECIFIC GRAVITY =	1.0
TANK MATERIAL -	MILD CARBON STEEL
THICKNESS - INNER -	7 GAUGE
THICKNESS - OUTER -	7 GAUGE
MIN. GAUGE OR THICKNESS (PER U.L. 2085)	
CONSTRUCTION - INNER -	LAP WELD OUTSIDE ONLY
CONSTRUCTION - OUTER -	LAP WELD OUTSIDE ONLY
TANK TEST - PER U.L. 2085	
INT. FINISH -	NONE
EXT. FINISH -	SP-6 BLAST, FINISH PAINT WHITE
LABEL -	UL 2085 AND FIREGUARD® PER stl

**LEGEND**

A	2" FEMALE FIREGUARD COUPLING
B	4" FEMALE FIREGUARD COUPLING
C	4" FEMALE FIREGUARD COUPLING - FOR PRIMARY EMERGENCY VENT USE
D	4" FITTING THROUGH OUTER SHELL ONLY, INTERSTITIAL EMERGENCY VENT USE ONLY
E	4" FITTING THROUGH OUTER SHELL ONLY WITH CAST IRON PLUG - MFG USE ONLY
F	2" INTERSTITIAL MONITOR PIPE - MALE NPT END

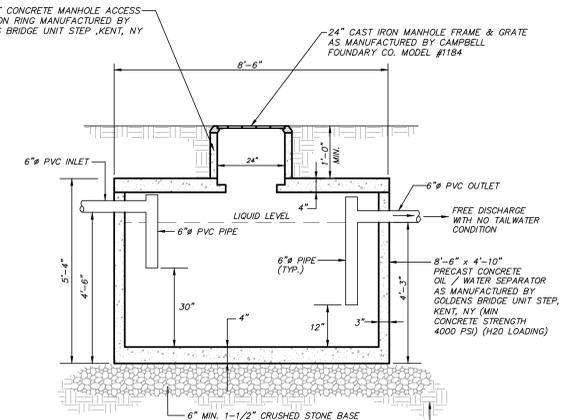

**1,000 GALLON OIL/WATER SEPARATOR DETAIL**  
(N.T.S.)

4	4-29-21	PLANNING BOARD SUBMISSION	MEU
3	10-8-20	PLANNING BOARD SUBMISSION	ERA
2	8-7-20	PLANNING BOARD SUBMISSION	KMG
1	7-17-20	PLANNING BOARD SUBMISSION	ERA
NO.	DATE	REVISION	BY

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(845) 225-9690  
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www.insite-eng.com

PROJECT: **CARMEL FIRE DEPARTMENT**  
94 GLENEDA AVENUE, CARMEL, PUTNAM COUNTY, NEW YORK

DRAWING: **DETAILS**

PROJECT NUMBER	19135.100	PROJECT MANAGER	J.M.W.	DRAWING NO.	10
DATE	5-20-20	DRAWN BY	J.F.R.		
SCALE	AS NOTED	CHECKED BY	K.M.G.		

ALTERATION OF THIS DOCUMENT, UNLESS UNDER THE DIRECTION OF A LICENSED PROFESSIONAL ENGINEER, IS A VIOLATION OF SECTION 2209 OF ARTICLE 145 OF THE EDUCATION LAW.




**PROPOSED SOUTH ELEVATION**


**PROPOSED MATERIALS:**



EXISTING BRICK

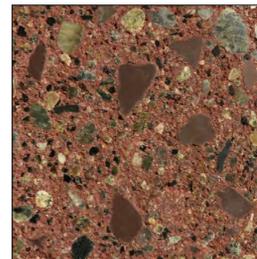


GROUND FACE ACMU - REDWOOD BRAND

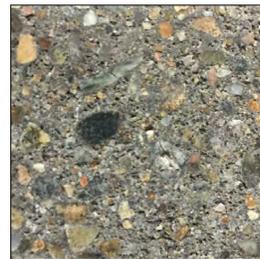


SPLIT FACE ACMU - LIGHT CHARCOAL



FIBER CEMENT SIDING - COBBLE STONE

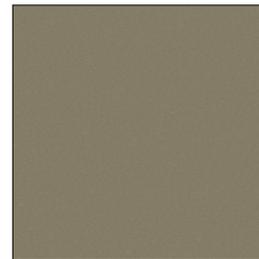

OVERHEAD DOOR - BEIGE

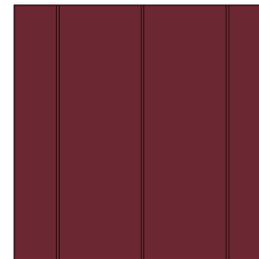

STANDING SEAM METAL ROOF - REDWOOD



ASPHALT SHINGLES - SLATESTONE GRAY

**H 2 architects + engineers**  
**M**

3 Lear Jet Lane, Suite 205  
Latham, NY 12110  
518.765.5105 • www.h2m.com

CONSULTANTS:

MARK	DATE	DESCRIPTION

DESIGNED BY: EJM/AFJ  
DRAWN BY: TES  
CHECKED BY: [ ]  
REVIEWED BY: [ ]

PROJECT No: CARM1902  
DATE: 10/20/2020  
SCALE: AS SHOWN

CLIENT

**CARMEL FIRE DEPARTMENT INC.**

PROPOSED ADDITION/RENOVATION




94 GLENEIDA AVE,  
CARMEL HAMLET NY, 10512

CONTRACT  
**ALL CONTRACTS**

STATUS  
**DD AUG/OCT 2020**

SHEET TITLE  
**PROPOSED SOUTH RENDERING AND PRELIMINARY MATERIALS**

DRAWING No.  
**AP1.0**

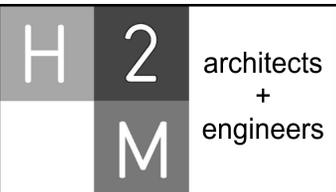

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MARK	DATE	DESCRIPTION

ALTERNATION OF THIS DOCUMENT EXCEPT BY A LICENSED PROFESSIONAL ENGINEER.

DESIGNED BY:	DRAWN BY:	CHECKED BY:	REVIEWED BY:
EJN/AFJ	TES		
PROJECT No: CARM1902	DATE: 10/20/2020	SCALE: AS SHOWN	

CLIENT

**CARMEL FIRE DEPARTMENT INC.**

PROPOSED  
ADDITION/RENOVATION



94 GLENEIDA AVE,  
CARMEL HAMLET NY, 10512

CONTRACT

ALL CONTRACTS

STATUS

DD AUG/OCT 2020

SHEET TITLE

PROPOSED WEST  
RENDERING


DRAWING No.

**AP1.1**



C:\Users\stevenson\H2M\Projects\CARM1902\_CENTRAL19\_ARCH\_Revise.dwg 10/20/2020 2:28:08 PM

SECOND FLOOR ROOM LEGEND	
#	Name
201	STAIRS
202	SECOND FLOOR LOBBY
203	CORRIDOR
204	STORAGE
E201	EXISTING APPARATUS BAYS
E202	DISPLAY ROOM
E203	MEETING ROOM
E205	FILE ROOM
E206	ADMIN OFFICE
E207	DISPATCH
E208	STORE ROOM
E209	COMPRESSOR
E210	OFFICE
E211	UTILITY ROOM
E212	PANTRY
E213	KITCHEN
E214	CORRIDOR
E216	STAIR
E217	MEN'S ROOM
E218	WOMEN'S ROOM
E219	MEETING HALL
M01	MEZZANINE
M02	MECH. ROOM

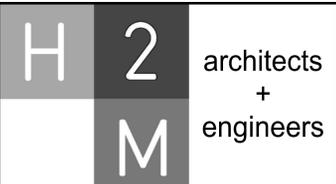

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CONSULTANTS:

MARK	DATE	DESCRIPTION

DESIGNED BY: EJN/AFJ	DRAWN BY: TES	CHECKED BY:	REVIEWED BY:
PROJECT No: CARM1902	DATE: 10/20/2020	SCALE: AS SHOWN	

**CARMEL FIRE DEPARTMENT INC.**

**PROPOSED ADDITION/RENOVATION**




94 GLENEIDA AVE,  
CARMEL HAMLET NY, 10512

CONTRACT  
**ALL CONTRACTS**

STATUS  
**DD AUG/OCT 2020**

SHEET TITLE  
**SECOND FLOOR & MEZZANINE PLAN**

DRAWING No.  
**AP1.3**

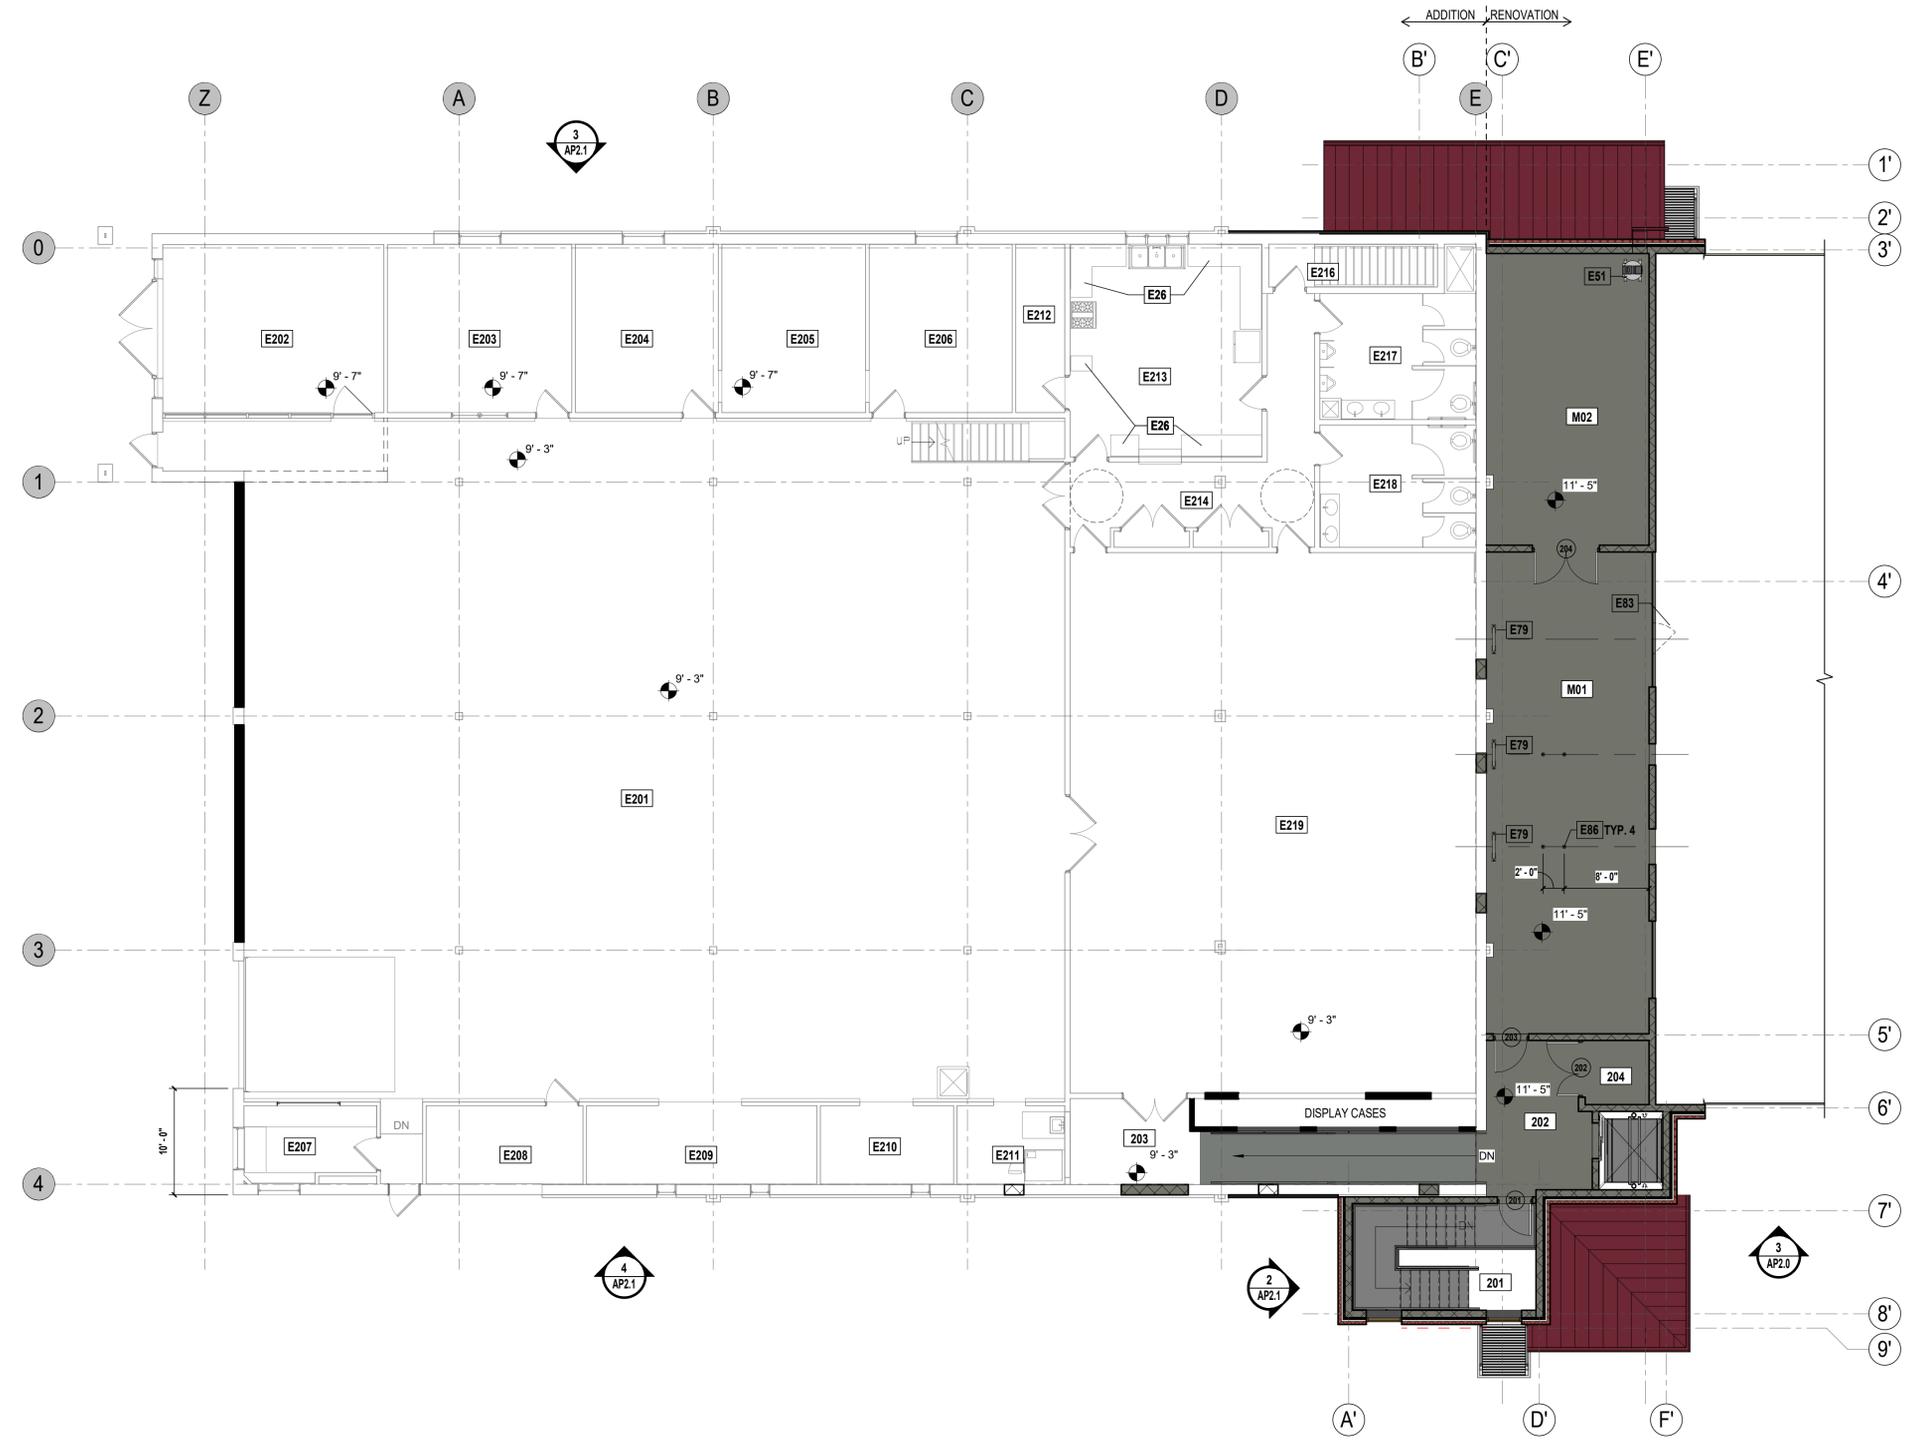

**1 PROPOSED SECOND FLOOR PLAN**  
SCALE: 1/8" = 1'-0"



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MARK	DATE	DESCRIPTION

DESIGNED BY: EJN/AFJ	DRAWN BY: TES	CHECKED BY:	REVIEWED BY:
PROJECT No: CARM1902	DATE: 10/20/2020	SCALE: AS SHOWN	

CLIENT  
**CARMEL FIRE DEPARTMENT INC.**

PROPOSED  
ADDITION/RENOVATION



94 GLENEIDA AVE,  
CARMEL HAMLET NY, 10512

CONTRACT  
**ALL CONTRACTS**


STATUS  
**DD AUG/OCT 2020**

SHEET TITLE  
**EXTERIOR ELEVATIONS**

DRAWING No.  
**AP2.0**




**1 PROPOSED NORTH ELEVATION - ADDITION**  
SCALE: 1/8" = 1'-0"

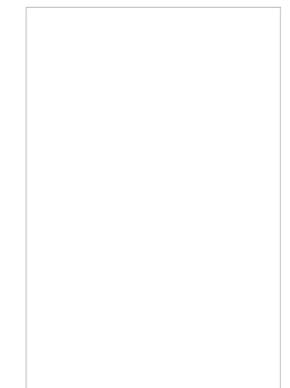

STANDING SEAM METAL ROOF - REDWOOD




ASPHALT SHINGLES - SLATESTONE GRAY

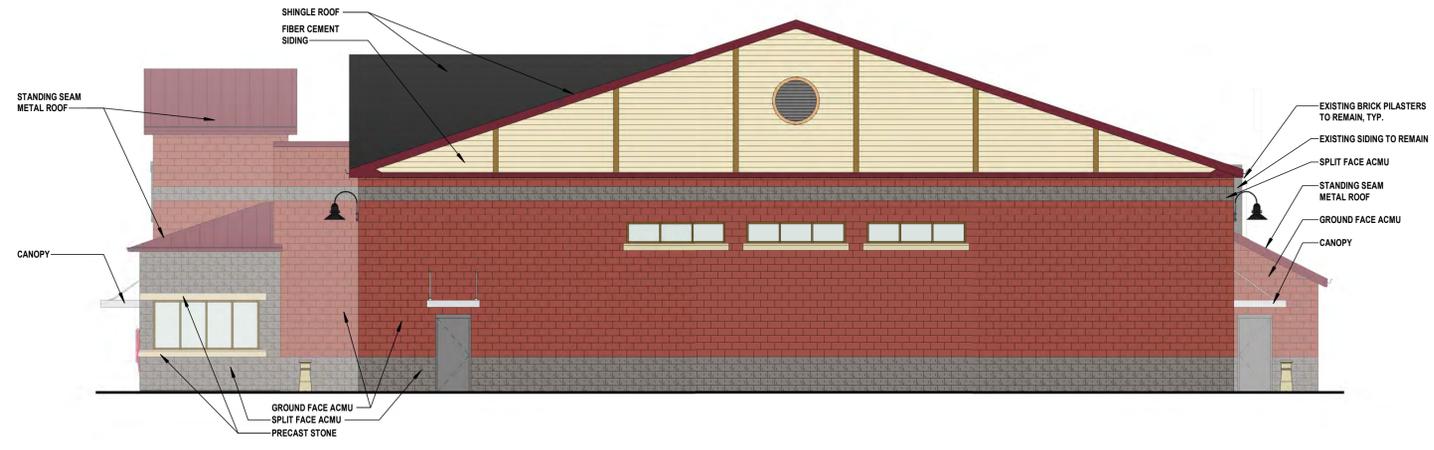


**2 PROPOSED EAST ELEVATION - ADDITION**  
SCALE: 1/8" = 1'-0"



FIBER CEMENT SIDING - COBBLE STONE

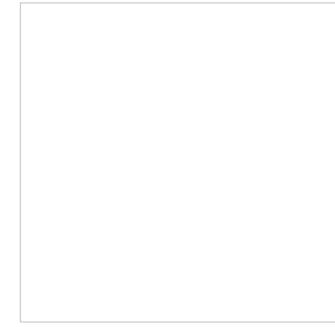


OVERHEAD DOOR - BEIGE

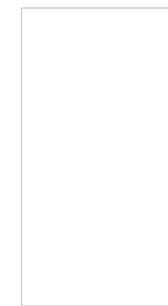


WINDOWS AND MISCELLANEOUS METALS - SANDSTONE




**3 PROPOSED SOUTH ELEVATION - ADDITION**  
SCALE: 1/8" = 1'-0"

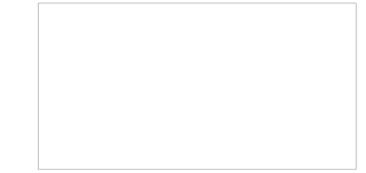

EXISTING BRICK

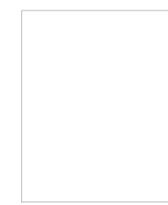

GROUND FACE ACMU - REDWOOD BRAND

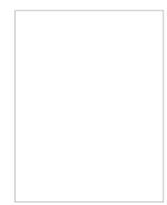

SPLIT FACE ACMU - LIGHT CHARCOAL

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CONSULTANTS:

MARK	DATE	DESCRIPTION

DESIGNED BY: EJN/AFJ	DRAWN BY: TES	CHECKED BY:	REVIEWED BY:
PROJECT No: CARM1902	DATE: 10/20/2020	SCALE:	AS SHOWN

CLIENT  
**CARMEL FIRE DEPARTMENT INC.**

PROPOSED  
ADDITION/RENOVATION




94 GLENEIDA AVE,  
CARMEL HAMLET NY, 10512

CONTRACT  
**ALL CONTRACTS**


STATUS  
**DD AUG/OCT 2020**

SHEET TITLE  
**EXTERIOR ELEVATIONS**

DRAWING No.  
**AP2.1**

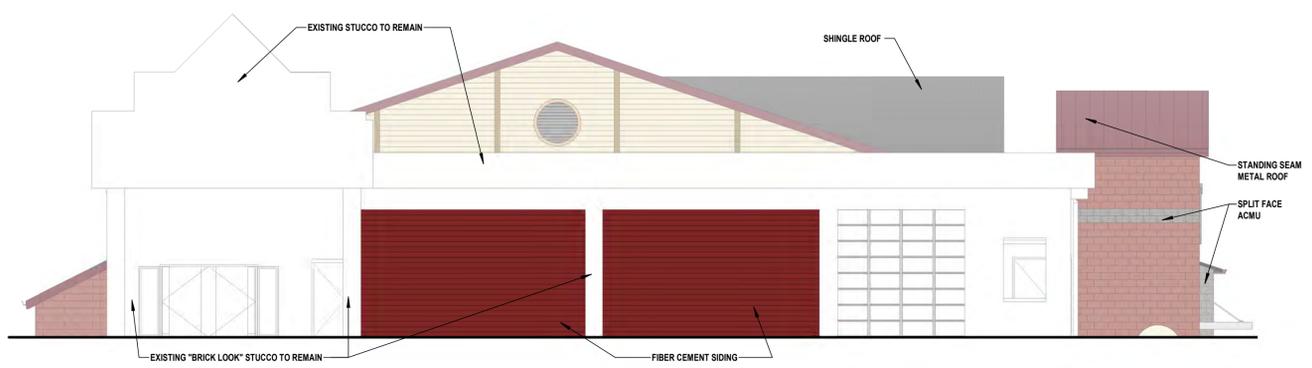


**1 PROPOSED WEST ELEVATION - RENOVATION**  
AP2.1 SCALE: 1/8" = 1'-0"

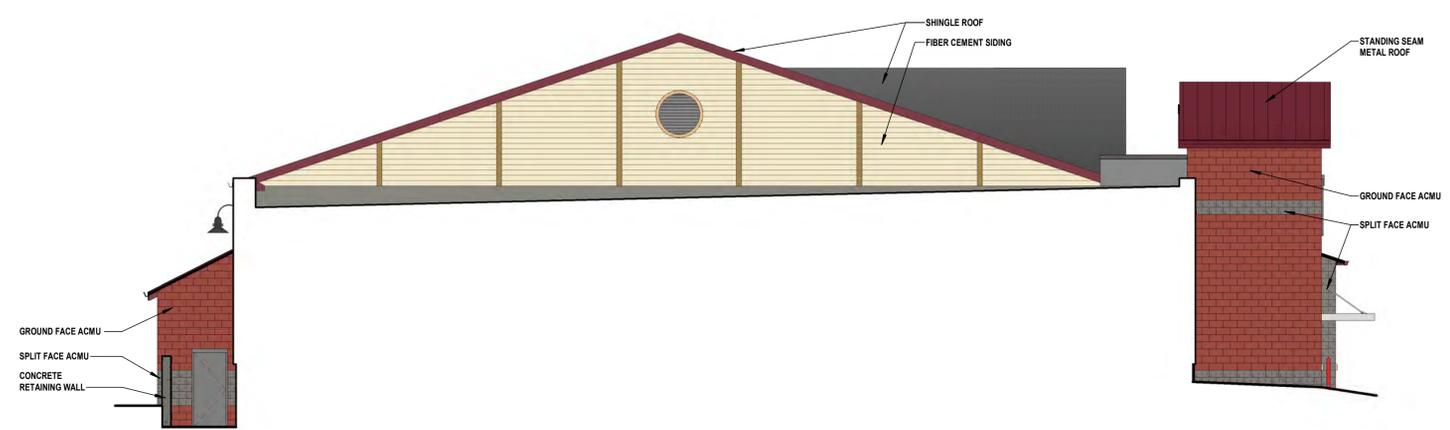


**2 PROPOSED WEST ELEVATION - ADDITION**  
AP2.1 SCALE: 1/8" = 1'-0"

**ALTERNATES**

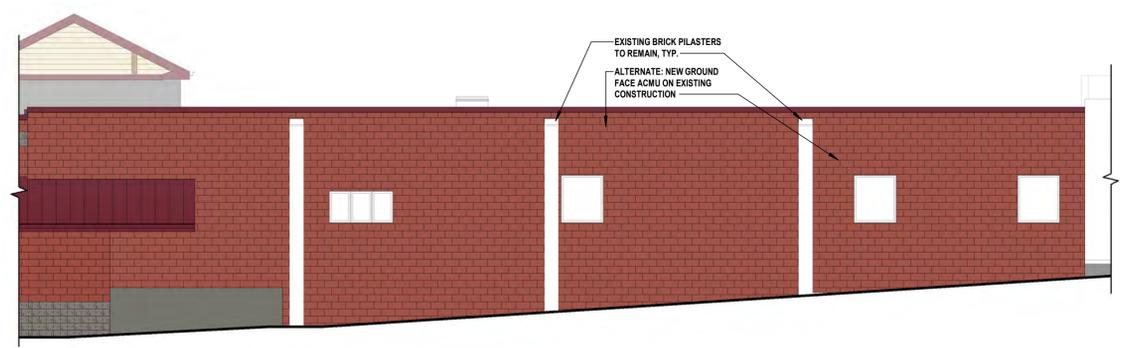

**3 PROPOSED NORTH ELEVATION - ALTERNATE**  
AP2.1 SCALE: 1/8" = 1'-0"

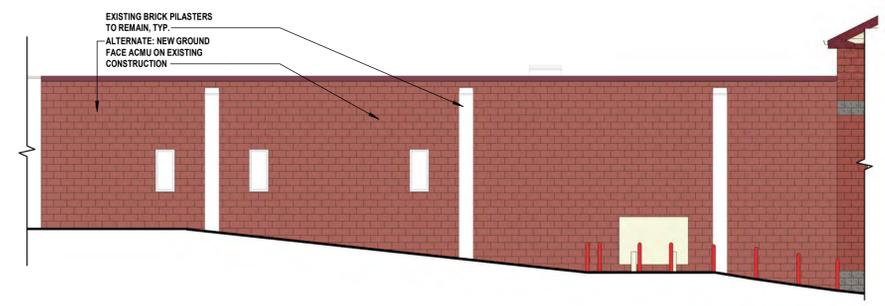

**4 PROPOSED SOUTH ELEVATION - ALTERNATE**  
AP2.1 SCALE: 1/8" = 1'-0"



April 27, 2021

Mr. Craig Paeprer, Chairman  
Town of Carmel Planning Board  
Carmel Town Hall  
60 McAlpin Avenue  
Mahopac, NY 10541

Re: Stacy Hirsch  
311 Drewville Road  
Carmel, NY  
T.M. 66.13-1-7  
Site Plan

Dear Chairman Paeprer and Members of the Board,

Ms. Hirsch received a use variance from the Zoning Board of Appeals in February 2020 in order to allow her to continue a dog boarding kennel business on her property.

Ms. Hirsch is seeking to construct a new indoor dog run with approximately 11' x 57' dimensions. She also wishes to take two exterior dog runs and turn them into indoor dog runs. The third action she would like to take would enable her to move her office and reception room which is currently in the garage of the residence to a new addition to be built alongside the building. The total area of new construction is approximately 1,400 square feet.

At present the property requires two variances, one for lot area and the other for lot width. We ask that the Board deny the sketch plan application and refer the applicant to the ZBA to obtain the variance required in order to return to the Planning Board to proceed with the site plan review.

Sincerely,

PUTNAM ENGINEERING, PLLC

A handwritten signature in black ink, appearing to read 'P. Lynch', written over a horizontal line.

Paul M. Lynch, P.E.  
PML/rrm

L1992



# TOWN OF CARMEL SITE PLAN APPLICATION INSTRUCTIONS



The Town of Carmel Planning Board meetings are held twice a month, on the second and fourth Wednesday's, at 7:00 PM at Carmel Town Hall, 60 McAlpin Avenue, Carmel

The submission deadline is 10 days prior to the Planning Board meeting. New site plan applications that have been deemed complete will be placed on the agenda in the order they are received.

**No application will be placed on the agenda that is incomplete**

**Pre-Submission:**

Prior to the formal submission of the site plan, a pre-submission conference may be requested by the applicant to be conducted with representatives from the Town, which may include the Town Planner, Town Engineer, Director of Code Enforcement and/or the Planning Board Attorney. This conference will serve to educate the applicant on the process he/she must follow, clarify the information required to submit a complete site plan application, and to highlight any specific areas of concern. You may arrange a pre-submission conference through the Planning Board Secretary at (845) 628-1500 extension 190.

**Submission Requirements:**

At least 10 days prior to the Planning Board meeting, the site plan application shall be submitted to the Planning Board Secretary as follows:

All site plans shall be signed, sealed and folded with the title box legible. The application package shall include:

- 11 copies of the Site Plan Application Form, signed and notarized.
- 11 copies of the SEQR Environmental Assessment Form (use of short form or long form shall be determined at pre-submission conference).
- 5 full size sets of the Site Plan (including floor plans and elevations)
- 1 CD (in pdf. format) containing an electronic version of the Site Plan
- 2 copies of the Disclosure Statement
- 11 copies of the Site Plan Completeness Certification Form
- All supplemental studies, reports, plans and renderings.
- 2 copies of the current deed.
- ~~NA~~ 2 copies of all easements, covenants and restrictions.
- The appropriate fee, determined from the attached fee schedule. Make checks payable to the *Town of Carmel*.

Rose Trombetta 5/4/21  
Planning Board Secretary; Date

[Signature] 5/4/21  
Town Engineer; Date



# TOWN OF CARMEL SITE PLAN APPLICATION



Per Town of Carmel Code – Section 156 - Zoning

SITE IDENTIFICATION INFORMATION		
<b>Application Name:</b> STACY HIRSCH	<b>Application #</b> 21-0005	<b>Date Submitted:</b> 4/27/21
<b>Site Address:</b> No. 311 Street: DREWVILLE RD Hamlet:		
<b>Property Location:</b> (Identify landmarks, distance from intersections, etc.) 800 FEET WEST OF CHERRY ROAD LOCATED ON SOUTH SIDE OF DREWVILLE		
<b>Town of Carmel Tax Map Designation:</b> Section 66.13 Block 1 Lot(s) 7	<b>Zoning Designation of Site:</b> R - RESIDENTIAL	
<b>Property Deed Recorded in County Clerk's Office</b> Date Liber Page	<b>Liens, Mortgages or other Encumbrances</b> <input checked="" type="radio"/> Yes <input type="radio"/> No	
<b>Existing Easements Relating to the Site</b> <input checked="" type="radio"/> No <input type="radio"/> Yes Describe and attach copies:	<b>Are Easements Proposed?</b> <input checked="" type="radio"/> No <input type="radio"/> Yes Describe and attach copies:	
<b>Have Property Owners within a 500' Radius of the Site Been Identified?</b> <input checked="" type="radio"/> Yes <input type="radio"/> No Attached List to this Application Form		
APPLICANT/OWNER INFORMATION		
<b>Property Owner:</b> STACY HIRSCH	<b>Phone #:</b> 914-393 1255 <b>Fax#:</b>	<b>Email:</b> stacyhirsche@hotmail.com
<b>Owners Address:</b> No. 311 Street: DREWVILLE ROAD Town: CARMEL State: NY Zip: 10512		
<b>Applicant (If different than owner):</b>	<b>Phone #:</b> <b>Fax#:</b>	<b>Email:</b>
<b>Applicant Address (If different than owner):</b> No. Street: Town: State: Zip:		
<b>Individual/ Firm Responsible for Preparing Site Plan:</b> PUTNAM ENGINEERING PLLC	<b>Phone #:</b> 845 279 6789 <b>Fax#:</b> 845-279 6769	<b>Email:</b> plynsche@putnameng.com
<b>Address:</b> No. 4 Street: OLD ROUTE 6 Town: BREWSTER State: NY Zip: 10509		
<b>Other Representatives:</b> WILLIAM A. SHILLING, JR., P.C.	<b>Phone #:</b> 845-225-7500 <b>Fax#:</b>	<b>Email:</b>
<b>Owners Address:</b> No. 122 Street: OLD ROUTE 6 Town: CARMEL State: NY Zip: 10512		
PROJECT DESCRIPTION		
<p><b>Describe the project, proposed use and operation thereof:</b></p> <p>THE APPLICANT IS LOOKING TO CONSTRUCT ADDITIONAL INDOOR DOG RUN AREAS AND TO EXPAND THE OFFICE PORTION OF THE BUSINESS SO AS NOT TO BE LOCATED IN THE GARAGE OF THE HOME.</p> <p>THE APPLICANT RECEIVED A USE VARIANCE FROM ZISA DATED 2/26/20, SIGNED 2/28/20</p>		

## TOWN OF CARMEL SITE PLAN APPLICATION

PROJECT INFORMATION			
Lot size: Acres: <u>1.487</u> Square Feet: <u>64,773</u>		Square footage of all existing structures (by floor): <u>3,211 S.F.</u>	
# of existing parking spaces: <u>8</u>		# of proposed parking spaces: <u>0</u>	
# of existing dwelling units: <u>1</u>		# of proposed dwelling units: <u>0</u>	
Is the site served by the following public utility infrastructure: <ul style="list-style-type: none"> <li>▪ Is project in sewer district or will private septic system(s) be installed? <u>EXISTING SSTS</u></li> <li>▪ If yes to Sanitary Sewer answer the following:                             <ul style="list-style-type: none"> <li>▶ Does approval exist to connect to sewer main? Yes: <input type="checkbox"/> No: <input checked="" type="checkbox"/></li> <li>▶ Is this an in-district connection? _____ Out-of district connection? _____</li> <li>▶ What is the total sewer capacity at time of application? _____</li> <li>▶ What is your anticipated average and maximum daily flow _____</li> </ul> </li> </ul>			
For Town of Carmel Town Engineer ▶ What is the sewer capacity <u>NA PD 4/19/201</u>			
<ul style="list-style-type: none"> <li>▪ Water Supply      Yes: <input checked="" type="checkbox"/> No: <input type="checkbox"/>  <span style="margin-left: 100px;"><u>ON SITE WELL</u></span></li> <li>If Yes:                             <ul style="list-style-type: none"> <li>▶ Does approval exist to connect to water main? Yes: <input type="checkbox"/> No: <input checked="" type="checkbox"/></li> <li>▶ What is the total water capacity at time of application? _____</li> <li>▶ What is your anticipated average and maximum daily demand _____</li> </ul> </li> <li>▪ Storm Sewer      Yes: <input type="checkbox"/> No: <input checked="" type="checkbox"/></li> <li>▪ Electric Service      Yes: <input checked="" type="checkbox"/> No: <input type="checkbox"/></li> <li>▪ Gas Service (<u>PROPANE</u>)      Yes: <input checked="" type="checkbox"/> No: <input type="checkbox"/></li> <li>• Telephone/Cable Lines      Yes: <input checked="" type="checkbox"/> No: <input type="checkbox"/></li> </ul>			
For Town of Carmel Town Engineer Water Flows <u>NA PD 4/19/201</u> Sewer Flows _____			
_____ Town Engineer; Date			
What is the predominant soil type(s) on the site? <u>PAXTON</u>		What is the approximate depth to water table? <u>NO DEEP TESTS DUG.</u>	
Site slope categories:		15-25% <u>20%</u> 25-35% <u>10%</u> >35% <u>10%</u>	
Estimated quantity of excavation:		Cut (C.Y.) <u>0</u> Fill (C.Y.) <u>0</u>	
Is Blasting Proposed      Yes: <input type="checkbox"/> No: <input checked="" type="checkbox"/> Unknown: <input type="checkbox"/>			
Is the site located in a designated Critical Environmental Area?      Yes: <input type="checkbox"/> No: <input checked="" type="checkbox"/>			
Does a curb cut exist on the site?      Yes: <input checked="" type="checkbox"/> No: <input type="checkbox"/>		Are new curb cuts proposed?      Yes: <input type="checkbox"/> No: <input checked="" type="checkbox"/>	
What is the sight distance? Left <u>500'</u> Right <u>500'</u>			
Is the site located within 500' of:			
• The boundary of an adjoining city, town or village			Yes: <input type="checkbox"/> No: <input checked="" type="checkbox"/>
• The boundary of a state or county park, recreation area or <u>road right-of-way</u>			Yes: <input checked="" type="checkbox"/> No: <input type="checkbox"/>
• A county drainage channel line.			Yes: <input checked="" type="checkbox"/> No: <input type="checkbox"/>
• The boundary of state or county owned land on which a building is located			Yes: <input type="checkbox"/> No: <input checked="" type="checkbox"/>

## TOWN OF CARMEL SITE PLAN APPLICATION

Is the site listed on the State or Federal Register of Historic Place (or substantially contiguous)  
 Yes:  No:

Is the site located in a designated floodplain?  
 Yes:  No:

Will the project require coverage under the Current NYSDEC Stormwater Regulations  
 Yes:  No:

Will the project require coverage under the Current NYCDEP Stormwater Regulations  
 Yes:  No:

Does the site disturb more than 5,000 sq ft  
 Yes:  No:

Does the site disturb more than 1 acre  
 Yes:  No:

Does the site contain freshwater wetlands?  
 Yes:  No:

Jurisdiction:  
 NYSDEC:  Town of Carmel:

*If present, the wetlands must be delineated in the field by a Wetland Professional, and survey located on the Site Plan.*

Are encroachments in regulated wetlands or wetland buffers proposed? Yes:  No:

Does this application require a referral to the Environmental Conservation Board? Yes:  No:

Does the site contain waterbodies, streams or watercourses? Yes:  No:

Are any encroachments, crossings or alterations proposed? Yes:  No:

Is the site located adjacent to New York City watershed lands? Yes:  No:

Is the project funded, partially or in total, by grants or loans from a public source?  
 Yes:  No:

Will municipal or private solid waste disposal be utilized?  
 Public:  Private:

Has this application been referred to the Fire Department? Yes:  No:


What is the estimated time of construction for the project?  
 N.A.

SEAF says yes

### ZONING COMPLIANCE INFORMATION

Zoning Provision	Required	Existing	Proposed
Lot Area	120,000	64,773	64,773
Lot Coverage	15%	6%	7.7%
Lot Width	200	154.7	154.7
Lot Depth	200	416.5	416.5
Front Yard	40	110.3	110.3
Side Yard	25	26.6	25.0
Rear Yard	40	165.9	128.0
Minimum Required Floor Area			
Floor Area Ratio			
Height	35' MAX	< 35'	< 35'
Off-Street Parking		8	8
Off-Street Loading			

## TOWN OF CARMEL SITE PLAN APPLICATION

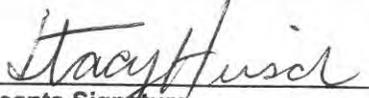Will variances be required? Yes: <input checked="" type="checkbox"/> No: <input type="checkbox"/>	If yes, identify variances: ① LOT WIDTH ② LOT AREA ③ ALLOW FOR THE CONTINUATION OF PRE EXISTING NON CONFORMING USE OF A KENNEL IN THE 'R' ZONE
<b>PROPOSED BUILDING MATERIALS</b>	
Foundation	CONCRETE
Structural System	WOOD FRAME
Roof	ASPHALT SHINGLE
Exterior Walls	VINYL SIDING
<b>APPLICANTS ACKNOWLEDGEMENT</b>	
I hereby depose and certify that all the above statements and information, and all statements and information contained in the supporting documents and drawings attached hereto are true and correct.	
<u>STACY HIRSCH</u> Applicants Name	 Applicants Signature
Sworn before me this <u>16<sup>th</sup></u> day of <u>April</u> 20 <u>21</u>	
 Notary Public	WILLIAM J LINDSAY NOTARY PUBLIC-STATE OF NEW YORK No. 01LI6356343 Qualified in Putnam County <u>25</u> My Commission Expires 03-27-2021



# TOWN OF CARMEL SITE PLAN COMPLETENESS CERTIFICATION FORM



All Site Plans submitted to the Planning Board for review shall include the following information and details, as set forth in Section 156-61 B of the Town of Carmel Zoning Ordinance.

This form shall be included with the site plan submission

	Requirement Data	To Be Completed by the Applicant,	Waived by the Town,
1	Name and title of person preparing the site plan	<input checked="" type="checkbox"/> ✓	<input type="checkbox"/>
2	Name of the applicant and owner (if different from applicant)	<input checked="" type="checkbox"/> ✓	<input type="checkbox"/>
3	Original drawing date, revision dates, scale and north arrow	<input checked="" type="checkbox"/> ✓	<input type="checkbox"/>
4	Tax map, block and lot number(s), zoning district	<input checked="" type="checkbox"/> ✓	<input type="checkbox"/>
5	All existing property lines, name of owner of each property within a 500' radius of the site	<input checked="" type="checkbox"/>	<input type="checkbox"/>
6	Contour lines at two-foot intervals, grades of all roads, driveways, sanitary and storm sewers	<input checked="" type="checkbox"/> ✓	<input type="checkbox"/>
7	The location of all water bodies, streams, watercourses, wetland areas, wooded areas, rights-of-way, streets, roads, highways, railroads, buildings, structures	<input checked="" type="checkbox"/> ✓	<input type="checkbox"/>
8	The location of all existing and proposed easements	<input type="checkbox"/> NA ✓	<input type="checkbox"/>
9	The location of all existing and proposed structures, their use, setback dimensions, floor plans, front, side and rear elevations, buildable area.	<input checked="" type="checkbox"/> ✓ NO FLOOR PLANS NO ELEVATIONS	<input type="checkbox"/>
10	On site circulation systems, access, egress ways and service roads, emergency service access and traffic mitigation measures	<input checked="" type="checkbox"/> ✓	<input type="checkbox"/>
11	Sidewalks, paths and other means of pedestrian circulation	<input checked="" type="checkbox"/> ✓	<input type="checkbox"/>
12	On-site parking and loading spaces and travel aisles with dimensions	<input checked="" type="checkbox"/> ✓	<input type="checkbox"/>
13	The location, height and type of exterior lighting fixtures	<input checked="" type="checkbox"/> NOTE 14 ✓	<input type="checkbox"/>
14	Proposed signage	✓ <input checked="" type="checkbox"/> NONE	<input type="checkbox"/>
15	For non-residential uses, an estimate of the number of employees who will be using the site, description of the operation, types of products sold, types of machinery and equipment used	<input checked="" type="checkbox"/> ✓	<input type="checkbox"/>

*7/11/09. btl*

*need to be*



# TOWN OF CARMEL SITE PLAN COMPLETENESS CERTIFICATION FORM



	Requirement Data	To Be Completed by the Applicant	Waived by the Town
16	The location of clubhouses, swimming pools, open spaces, parks or other recreational areas, and identification of who is responsible for maintenance	<input type="checkbox"/> NA	<input type="checkbox"/>
17	The location and design of buffer areas, screening or other landscaping, including grading and water management. A comprehensive landscaping plan in accordance with the Tree Conservation Law	<input type="checkbox"/> EXISTING	<input type="checkbox"/>
18	The location of public and private utilities, maintenance responsibilities, trash and garbage areas	<input checked="" type="checkbox"/>	<input type="checkbox"/>
19	A list, certified by the Town Assessor, of all property owners within 500 feet of the site boundary	<input checked="" type="checkbox"/> NOT CERTIFIED	<input type="checkbox"/>
20	Any other information required by the Planning Board which is reasonably necessary to ascertain compliance with this chapter	<input type="checkbox"/>	<input type="checkbox"/>

**Applicants Certification (to be completed by the licensed professional preparing the site plan:**

I PAUL M. LYNCH hereby certify that the site plan to which I have attached my seal and signature, meets all of the requirements of §156-61B of the Town of Carmel Zoning Ordinance:



**Professionals Seal**

Jay Aron  
Signature - Applicant

4/16/21  
Date

Stacy Aron  
Signature Owner

4/16/21  
Date



# TOWN OF CARMEL SITE PLAN COMPLETENESS CERTIFICATION FORM



Town Certification (to be completed by the Town)

I \_\_\_\_\_ hereby confirm that the site plan meets all of the requirements of §156-61B of the Town of Carmel Zoning Ordinance:

Rose Yonkette

Signature - Planning Board Secretary

5/4/21

Date

Bradly P. O'Dell

Signature - Town Engineer

5/4/2021

Date

# Short Environmental Assessment Form

## Part 1 - Project Information

### Instructions for Completing


**Part 1 – Project Information.** The applicant or project sponsor is responsible for the completion of Part 1. Responses become part of the application for approval or funding, are subject to public review, and may be subject to further verification. Complete Part 1 based on information currently available. If additional research or investigation would be needed to fully respond to any item, please answer as thoroughly as possible based on current information.

Complete all items in Part 1. You may also provide any additional information which you believe will be needed by or useful to the lead agency; attach additional pages as necessary to supplement any item.



<b>Part 1 – Project and Sponsor Information</b>			
Name of Action or Project: Hirsch Site Plan			
Project Location (describe, and attach a location map): 311 Drewville Road, Carmel, New York 10512			
Brief Description of Proposed Action: This is an existing developed lot that contains a residence and a kennel on it. The action being undertaken is a combination of receiving Zoning Board Variances for lot width and lot area in order to proceed with the local Planning Board to receive Site Plan approval to construct additions to the building which will house indoor dog runs and office space.			
Name of Applicant or Sponsor: Stacy Hirsch		Telephone: 914 393 1255 E-Mail: stacyhirsch@hotmail.com	
Address: 311 Drewville Road			
City/PO: Carmel		State: New York	Zip Code: 10509
1. Does the proposed action only involve the legislative adoption of a plan, local law, ordinance, administrative rule, or regulation? If Yes, attach a narrative description of the intent of the proposed action and the environmental resources that may be affected in the municipality and proceed to Part 2. If no, continue to question 2.			NO <input type="checkbox"/>
2. Does the proposed action require a permit, approval or funding from any other government Agency? If Yes, list agency(s) name and permit or approval:			YES <input type="checkbox"/>
3. a. Total acreage of the site of the proposed action? _____ 1.487 acres b. Total acreage to be physically disturbed? _____ 0.037 acres c. Total acreage (project site and any contiguous properties) owned or controlled by the applicant or project sponsor? _____ 1.48 acres			
4. Check all land uses that occur on, are adjoining or near the proposed action:			
5. <input type="checkbox"/> Urban <input checked="" type="checkbox"/> Rural (non-agriculture) <input type="checkbox"/> Industrial <input checked="" type="checkbox"/> Commercial <input checked="" type="checkbox"/> Residential (suburban) <input checked="" type="checkbox"/> Forest <input type="checkbox"/> Agriculture <input type="checkbox"/> Aquatic <input checked="" type="checkbox"/> Other(Specify): Reservoir <input type="checkbox"/> Parkland			

		NO	YES	N/A
5. Is the proposed action,	a. A permitted use under the zoning regulations?	<input type="checkbox"/>	<input checked="" type="checkbox"/>	<input type="checkbox"/>
	b. Consistent with the adopted comprehensive plan?	<input type="checkbox"/>	<input checked="" type="checkbox"/>	<input type="checkbox"/>
6. Is the proposed action consistent with the predominant character of the existing built or natural landscape?		NO	YES	
		<input type="checkbox"/>	<input checked="" type="checkbox"/>	
7. Is the site of the proposed action located in, or does it adjoin, a state listed Critical Environmental Area?		NO	YES	
If Yes, identify: _____		<input checked="" type="checkbox"/>	<input type="checkbox"/>	
8. a. Will the proposed action result in a substantial increase in traffic above present levels?		NO	YES	
		<input checked="" type="checkbox"/>	<input type="checkbox"/>	
	b. Are public transportation services available at or near the site of the proposed action?	<input checked="" type="checkbox"/>	<input type="checkbox"/>	
	c. Are any pedestrian accommodations or bicycle routes available on or near the site of the proposed action?	<input type="checkbox"/>	<input checked="" type="checkbox"/>	
9. Does the proposed action meet or exceed the state energy code requirements?		NO	YES	
If the proposed action will exceed requirements, describe design features and technologies: _____ _____		<input checked="" type="checkbox"/>	<input type="checkbox"/>	
10. Will the proposed action connect to an existing public/private water supply?		NO	YES	
If No, describe method for providing potable water: _____ Existing on site well, _____		<input checked="" type="checkbox"/>	<input type="checkbox"/>	
11. Will the proposed action connect to existing wastewater utilities?		NO	YES	
If No, describe method for providing wastewater treatment: _____ Existing on site septic treatment system _____		<input checked="" type="checkbox"/>	<input type="checkbox"/>	
12. a. Does the project site contain, or is it substantially contiguous to, a building, archaeological site, or district which is listed on the National or State Register of Historic Places, or that has been determined by the Commissioner of the NYS Office of Parks, Recreation and Historic Preservation to be eligible for listing on the State Register of Historic Places?		NO	YES	
		<input checked="" type="checkbox"/>	<input type="checkbox"/>	
b. Is the project site, or any portion of it, located in or adjacent to an area designated as sensitive for archaeological sites on the NY State Historic Preservation Office (SHPO) archaeological site inventory?		<input checked="" type="checkbox"/>	<input type="checkbox"/>	
13. a. Does any portion of the site of the proposed action, or lands adjoining the proposed action, contain wetlands or other waterbodies regulated by a federal, state or local agency?		NO	YES	
		<input type="checkbox"/>	<input checked="" type="checkbox"/>	
b. Would the proposed action physically alter, or encroach into, any existing wetland or waterbody?		<input checked="" type="checkbox"/>	<input type="checkbox"/>	
If Yes, identify the wetland or waterbody and extent of alterations in square feet or acres: _____ _____ _____				




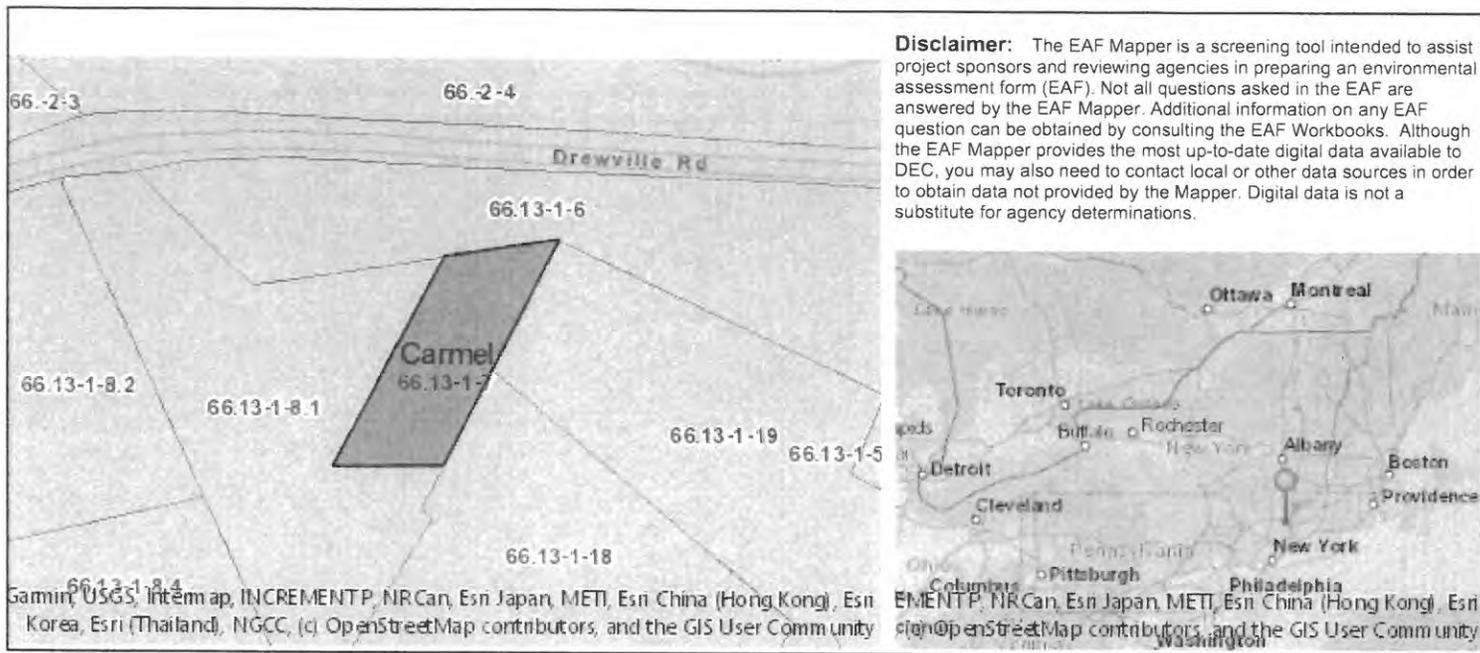

Part 1 / Question 7 [Critical Environmental Area]	No
Part 1 / Question 12a [National or State Register of Historic Places or State Eligible Sites]	No
Part 1 / Question 12b [Archeological Sites]	No
Part 1 / Question 13a [Wetlands or Other Regulated Waterbodies]	Yes - Digital mapping information on local and federal wetlands and waterbodies is known to be incomplete. Refer to EAF Workbook.
Part 1 / Question 15 [Threatened or Endangered Animal]	Yes
Part 1 / Question 15 [Threatened or Endangered Animal - Name]	Northern Long-eared Bat
Part 1 / Question 16 [100 Year Flood Plain]	No
Part 1 / Question 20 [Remediation Site]	No

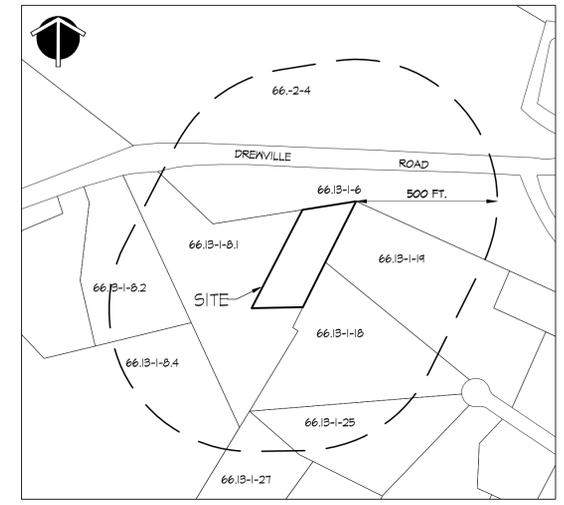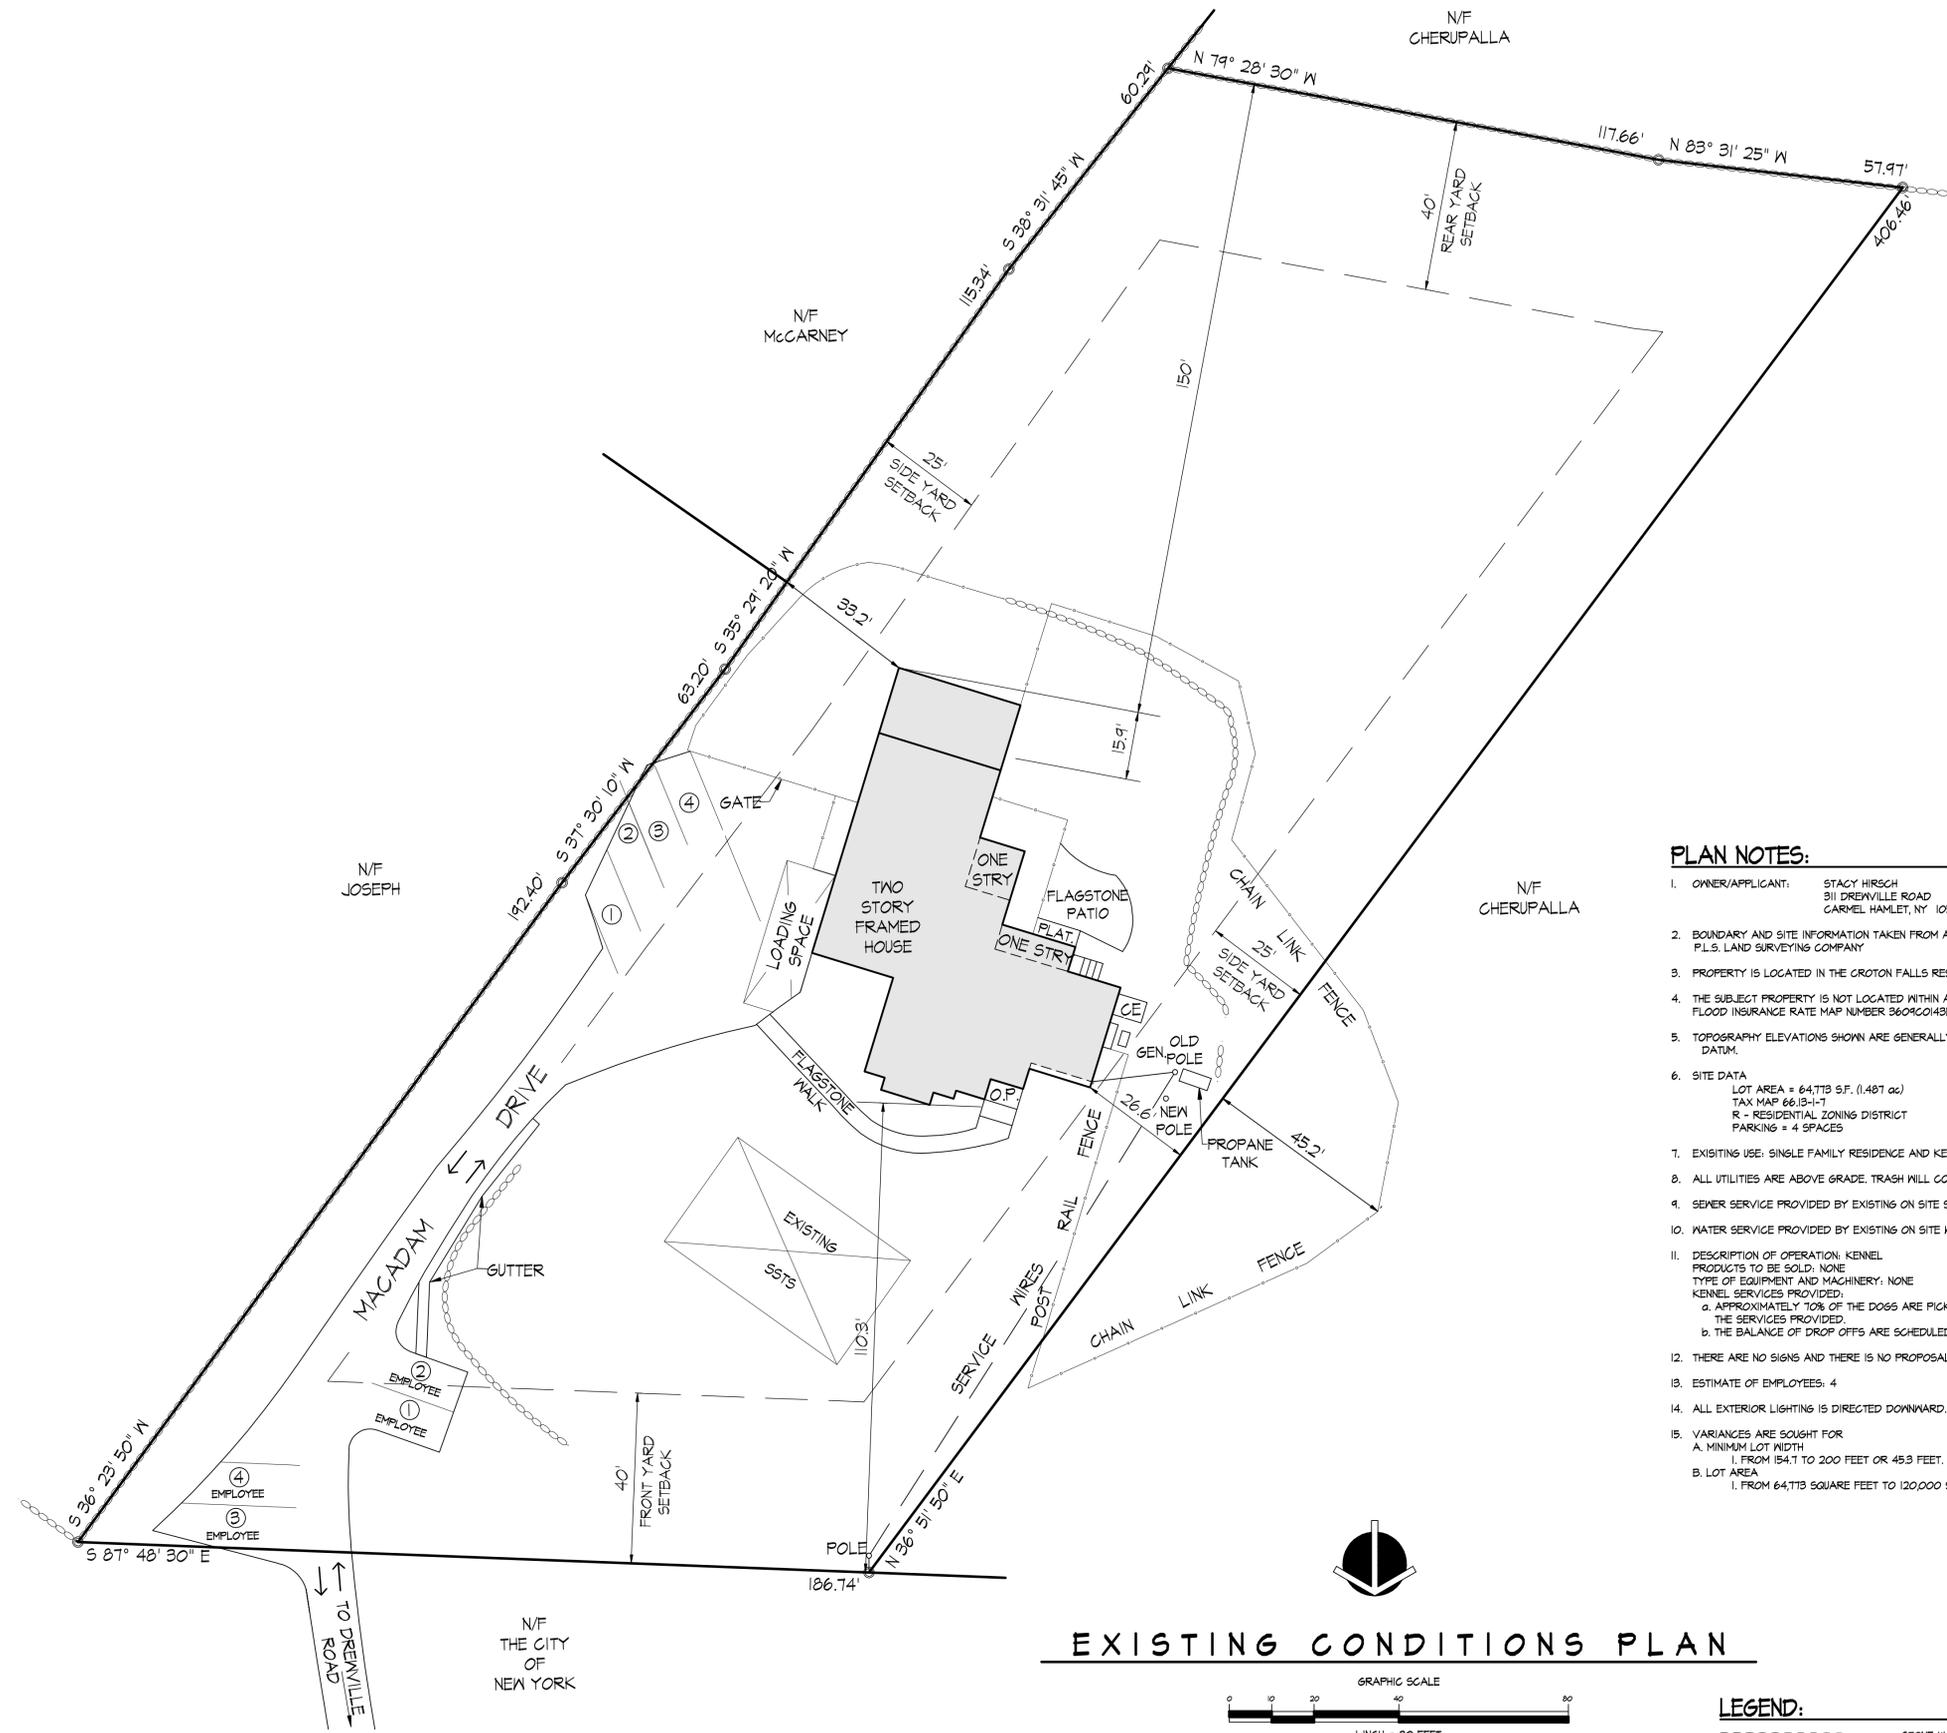

**AREA MAP**  
SCALE: 1" = 300'

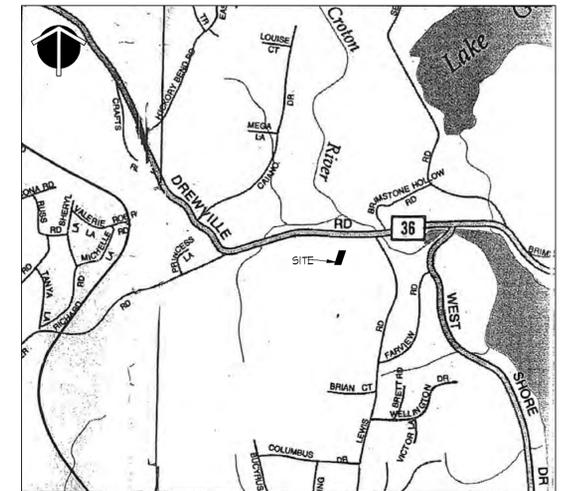

**LOCATION MAP**  
SCALE: 1" = 500'

**PLAN NOTES:**

- OWNER/APPLICANT: STACY HIRSCH  
311 DRENVILLE ROAD  
CARMEL HAMLET, NY 10512
- BOUNDARY AND SITE INFORMATION TAKEN FROM A SURVEY PREPARED BY DAVID L. ODELL, P.L.S. LAND SURVEYING COMPANY.
- PROPERTY IS LOCATED IN THE CROTON FALLS RESERVOIR BASIN.
- THE SUBJECT PROPERTY IS NOT LOCATED WITHIN A 100 YEAR FLOOD ZONE AS SHOWN ON FLOOD INSURANCE RATE MAP NUMBER 36090143E, DATED 9/4/2013.
- TOPOGRAPHY ELEVATIONS SHOWN ARE GENERALLY IN ACCORDANCE WITH NAVD 1988 DATUM.
- SITE DATA  
LOT AREA = 64,713 S.F. (1.481 ac)  
TAX MAP 66.13-1-7  
R - RESIDENTIAL ZONING DISTRICT  
PARKING = 4 SPACES
- EXISTING USE: SINGLE FAMILY RESIDENCE AND KENNEL
- ALL UTILITIES ARE ABOVE GRADE. TRASH WILL CONTINUE TO BE PICKED UP.
- SEWER SERVICE PROVIDED BY EXISTING ON SITE SUBSURFACE TREATMENT SYSTEM.
- WATER SERVICE PROVIDED BY EXISTING ON SITE WELL.
- DESCRIPTION OF OPERATION: KENNEL  
PRODUCTS TO BE SOLD: NONE  
TYPE OF EQUIPMENT AND MACHINERY: NONE  
KENNEL SERVICES PROVIDED:  
a. APPROXIMATELY 70% OF THE DOGS ARE PICKED UP AND DROPPED OFF AS PART OF THE SERVICES PROVIDED.  
b. THE BALANCE OF DROP OFFS ARE SCHEDULED FOR SPECIFIC TIMES
- THERE ARE NO SIGNS AND THERE IS NO PROPOSAL TO CONSTRUCT A SIGN.
- ESTIMATE OF EMPLOYEES: 4
- ALL EXTERIOR LIGHTING IS DIRECTED DOWNWARD.
- VARIANCES ARE SOUGHT FOR  
A. MINIMUM LOT WIDTH  
1. FROM 154.1 TO 200 FEET OR 45.3 FEET.  
B. LOT AREA  
1. FROM 64,713 SQUARE FEET TO 120,000 SQ. FT. OR 55,221 SQ. FT.

**SCHEDULE OF DISTRICT REGULATIONS:**

R - RESIDENTIAL	REQUIRED	EXISTING	PROPOSED
MIN. LOT AREA *	120,000 SF	64,713 S.F.	64,713 S.F.
MIN. LOT WIDTH *	200 FT	154.10	154.10
MIN. LOT DEPTH	200 FT	416.53	416.53
MINIMUM YARDS / PRINCIPAL			
FRONT	40 FT	110.3	110.3
SIDE	25 FT	26.6	25.0
REAR	40 FT	165.4	123
MINIMUM YARDS / ACCESSORY			
FRONT	40 FT	> 110.3	> 110
SIDE	20 FT	33.2	25
REAR	20 FT	150.0	123
MAX. BLDG. HEIGHT	35 FT	< 35	< 35
MAX. LOT COVERAGE	15%	6%	7.7%

**PROPERTIES WITHIN 500':**

66-2-4	City of New York	71 Smith Ave Kingston NY 12401
66.13-1-6	City of New York	71 Smith Ave Kingston NY 12401
66.13-1-18	Karen L. McCarney & Patrick W. McCarney	24 Brian Ct Carmel NY 10512
66.13-1-19	David Joseph & Kathie Ann Joseph	22 Brian Ct Carmel NY 10512
66.13-1-25	Jay Mink & Carolyn Mink	25 Brian Ct Carmel NY 10512
66.13-1-27	Jorge Pereira & Cassial J Pereira	64 Hayley Hill Dr Carmel NY 10512
66.13-1-81	Shyam R. Cherupalla & Jayashree S. Cherupalla	243 Drenville Rd Carmel NY 10512
66.13-1-82	Juliette Faulkner Dudowitz	291 Drenville Rd Carmel NY 10512
66.13-1-84	William & Regan & Sandra H Regan	274 Drenville Rd Carmel NY 10512

**EXISTING CONDITIONS PLAN**



**LEGEND:**



4 OLD ROUTE 6, BREWSTER, NEW YORK 10504  
(845) 279-6789 FAX (845) 279-6769  
● PUTNAM ENGINEERING PLLC 2016

PURSUANT TO NEW YORK STATE EDUCATION LAW, ARTICLE 145, SECTION 7209 SUBDIVISION 2, "IT IS A VIOLATION OF THIS LAW FOR ANY PERSON UNLESS HE IS ACTING UNDER THE DIRECTION OF A LICENSED PROFESSIONAL ENGINEER, TO ALTER AN ITEM IN ANY WAY. IF AN ITEM BEARING THE SEAL OF AN ENGINEER IS ALTERED, THE ALTERING ENGINEER SHALL AFFIX TO THE ITEM HIS SEAL AND THE NOTATION "ALTERED BY" FOLLOWED BY HIS SIGNATURE AND THE DATE OF SUCH ALTERATION, AND A SPECIFIC DESCRIPTION OF THE ALTERATION."

REVISIONS		
NO.	DATE	DESCRIPTION
1	04 MAY 2021	PER T.E. COMMENTS


APPLICANT: PLAN PREPARED FOR:  
**STACY HIRSCH**

LOCATION: 311 DRENVILLE ROAD, CARMEL, NY 10512  
TOWN OF CARMEL  
PUTNAM COUNTY, NEW YORK  
TAX MAP 66.13, BLOCK 1, LOT 7

DATE: 16 MAY 14  
PROJECT MANAGER: PML  
DRAWN BY: [Signature]  
CHECKED BY: PML  
SCALE: AS NOTED

DRAWING: **EXISTING SITE PLAN LAYOUT**

PROJECT NUMBER: 0355  
DRAWING NUMBER: **S-1**  
SHEET 1 OF 2

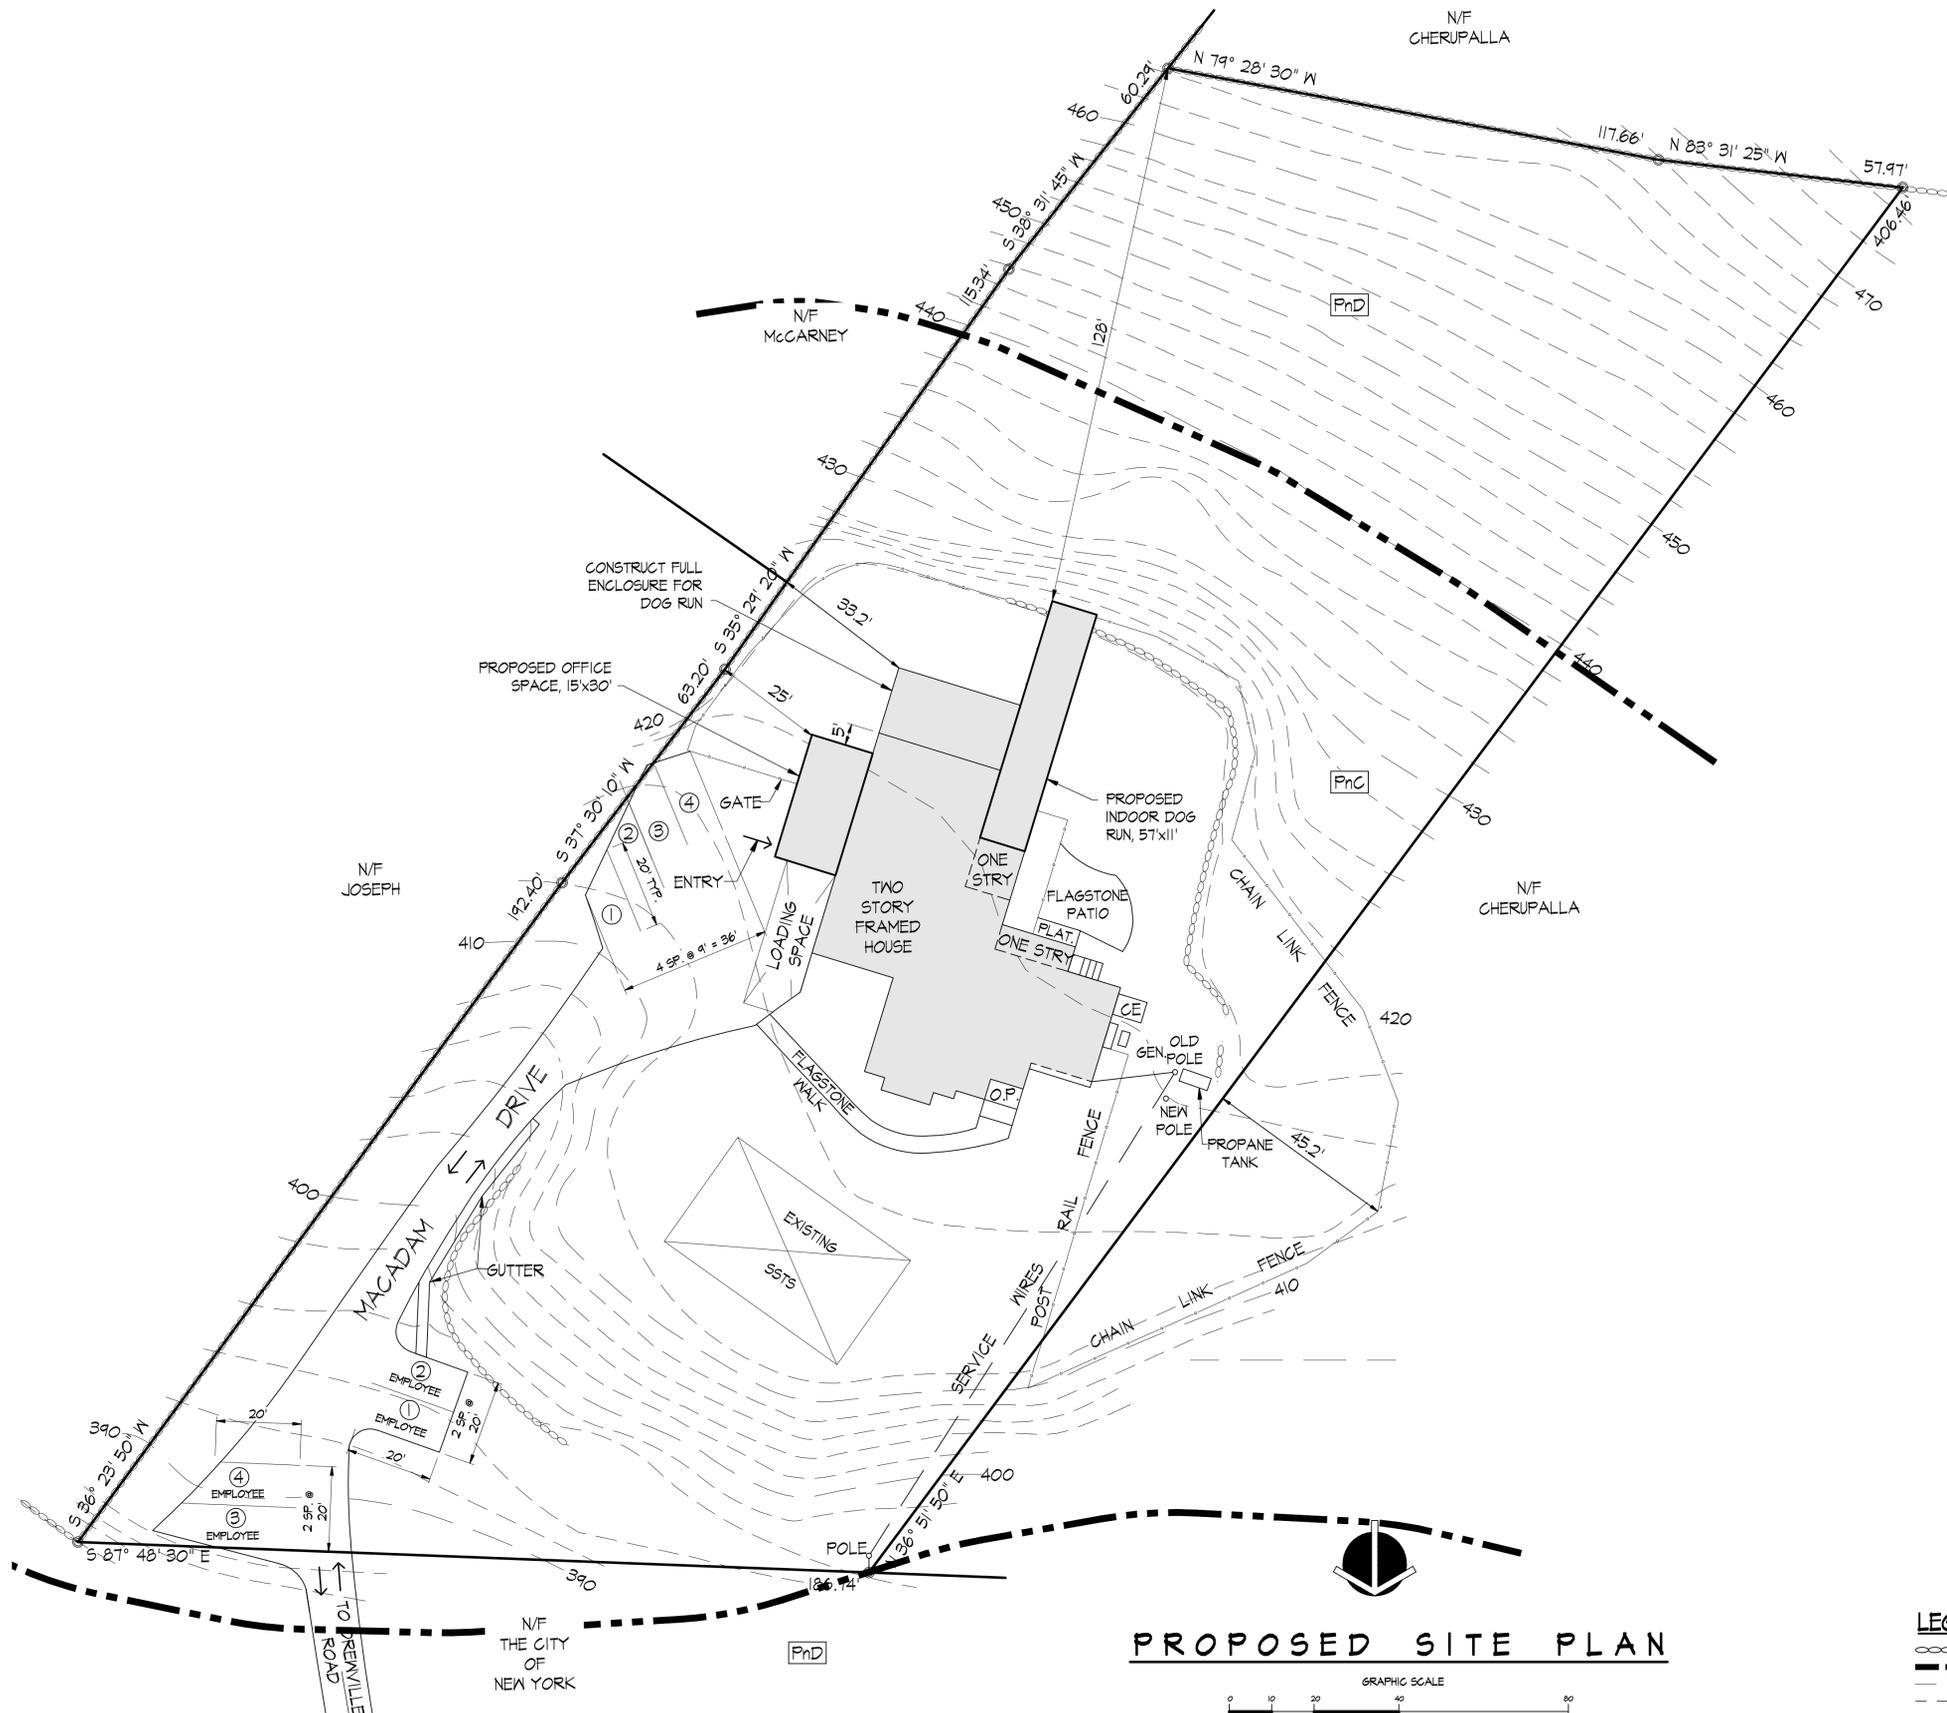

**PROPOSED SITE PLAN**

**LEGEND:**

- STONE WALL
- SOIL BOUNDARY
- EXISTING 10' CONTOURS
- EXISTING 2' CONTOURS
- SOIL TYPE
- EXISTING FENCE

SOILS LEGEND		
SOIL SYMBOL	SOIL GROUP	SOIL NAME
PnC	C	PAXTON FINE SANDY LOAM (0-15%)
PnD	C	PAXTON FINE SANDY LOAM (15-25%)

**PUTNAM ENGINEERING, PLLC**  
ENGINEERS - ARCHITECTS

4 OLD ROUTE 6, BREWSTER, NEW YORK 10504  
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REVISIONS		
NO.	DATE	DESCRIPTION
1	04 MAY 2021	PER T.E. COMMENTS

APPLICANT: PLAN PREPARED FOR:  
**STACY HIRSCH**

LOCATION: 311 DRENVILLE ROAD, CARMEL, NY 10512  
TOWN OF CARMEL  
PUTNAM COUNTY, NEW YORK  
TAX MAP 66.13, BLOCK 1, LOT 1

DATE: 16 MAY 14  
PROJECT MANAGER: PML  
DRAWN BY: PML  
CHECKED BY: PML  
SCALE: AS NOTED

DRAWING: **PROPOSED SITE PLAN**

PROJECT NUMBER: 0255  
DRAWING NUMBER: **S-2**  
SHEET 2 OF 2



April 28, 2021

Mr. Craig Paeprer, Chairman  
Town of Carmel Planning Board  
Carmel Town Hall  
60 McAlpin Avenue  
Mahopac, NY 10541

Re: Old Forge Estates  
Extension of Preliminary Approval

Dear Chairman Paeprer and Members of the Board,

On behalf of my client I am requesting that we be placed on the May agenda in order to have our preliminary approval extended. The original approval was granted November 24, 2020 and is set to expire May 24, 2021.

In addition I request that condition # 8 of the 'Conditions Prior to Final Plat Approval' be amended to strike the phrase 'maintenance of the private road' as our intention and presentation has been to dedicate the road to the Town of Carmel. This phrase is currently causing issues regarding forming the Homeowners association as the attorneys preparing quotes are taking private road into their considerations and the estimates reflect this.

Sincerely,

PUTNAM ENGINEERING, PLLC

A handwritten signature in black ink, appearing to read 'Paul M. Lynch', is written over a horizontal line.

Paul M. Lynch, P.E.  
PML/rmm

L1993